


MATCHLINE SEE SHEET 5

MATCHLINE SEE SHEET 7

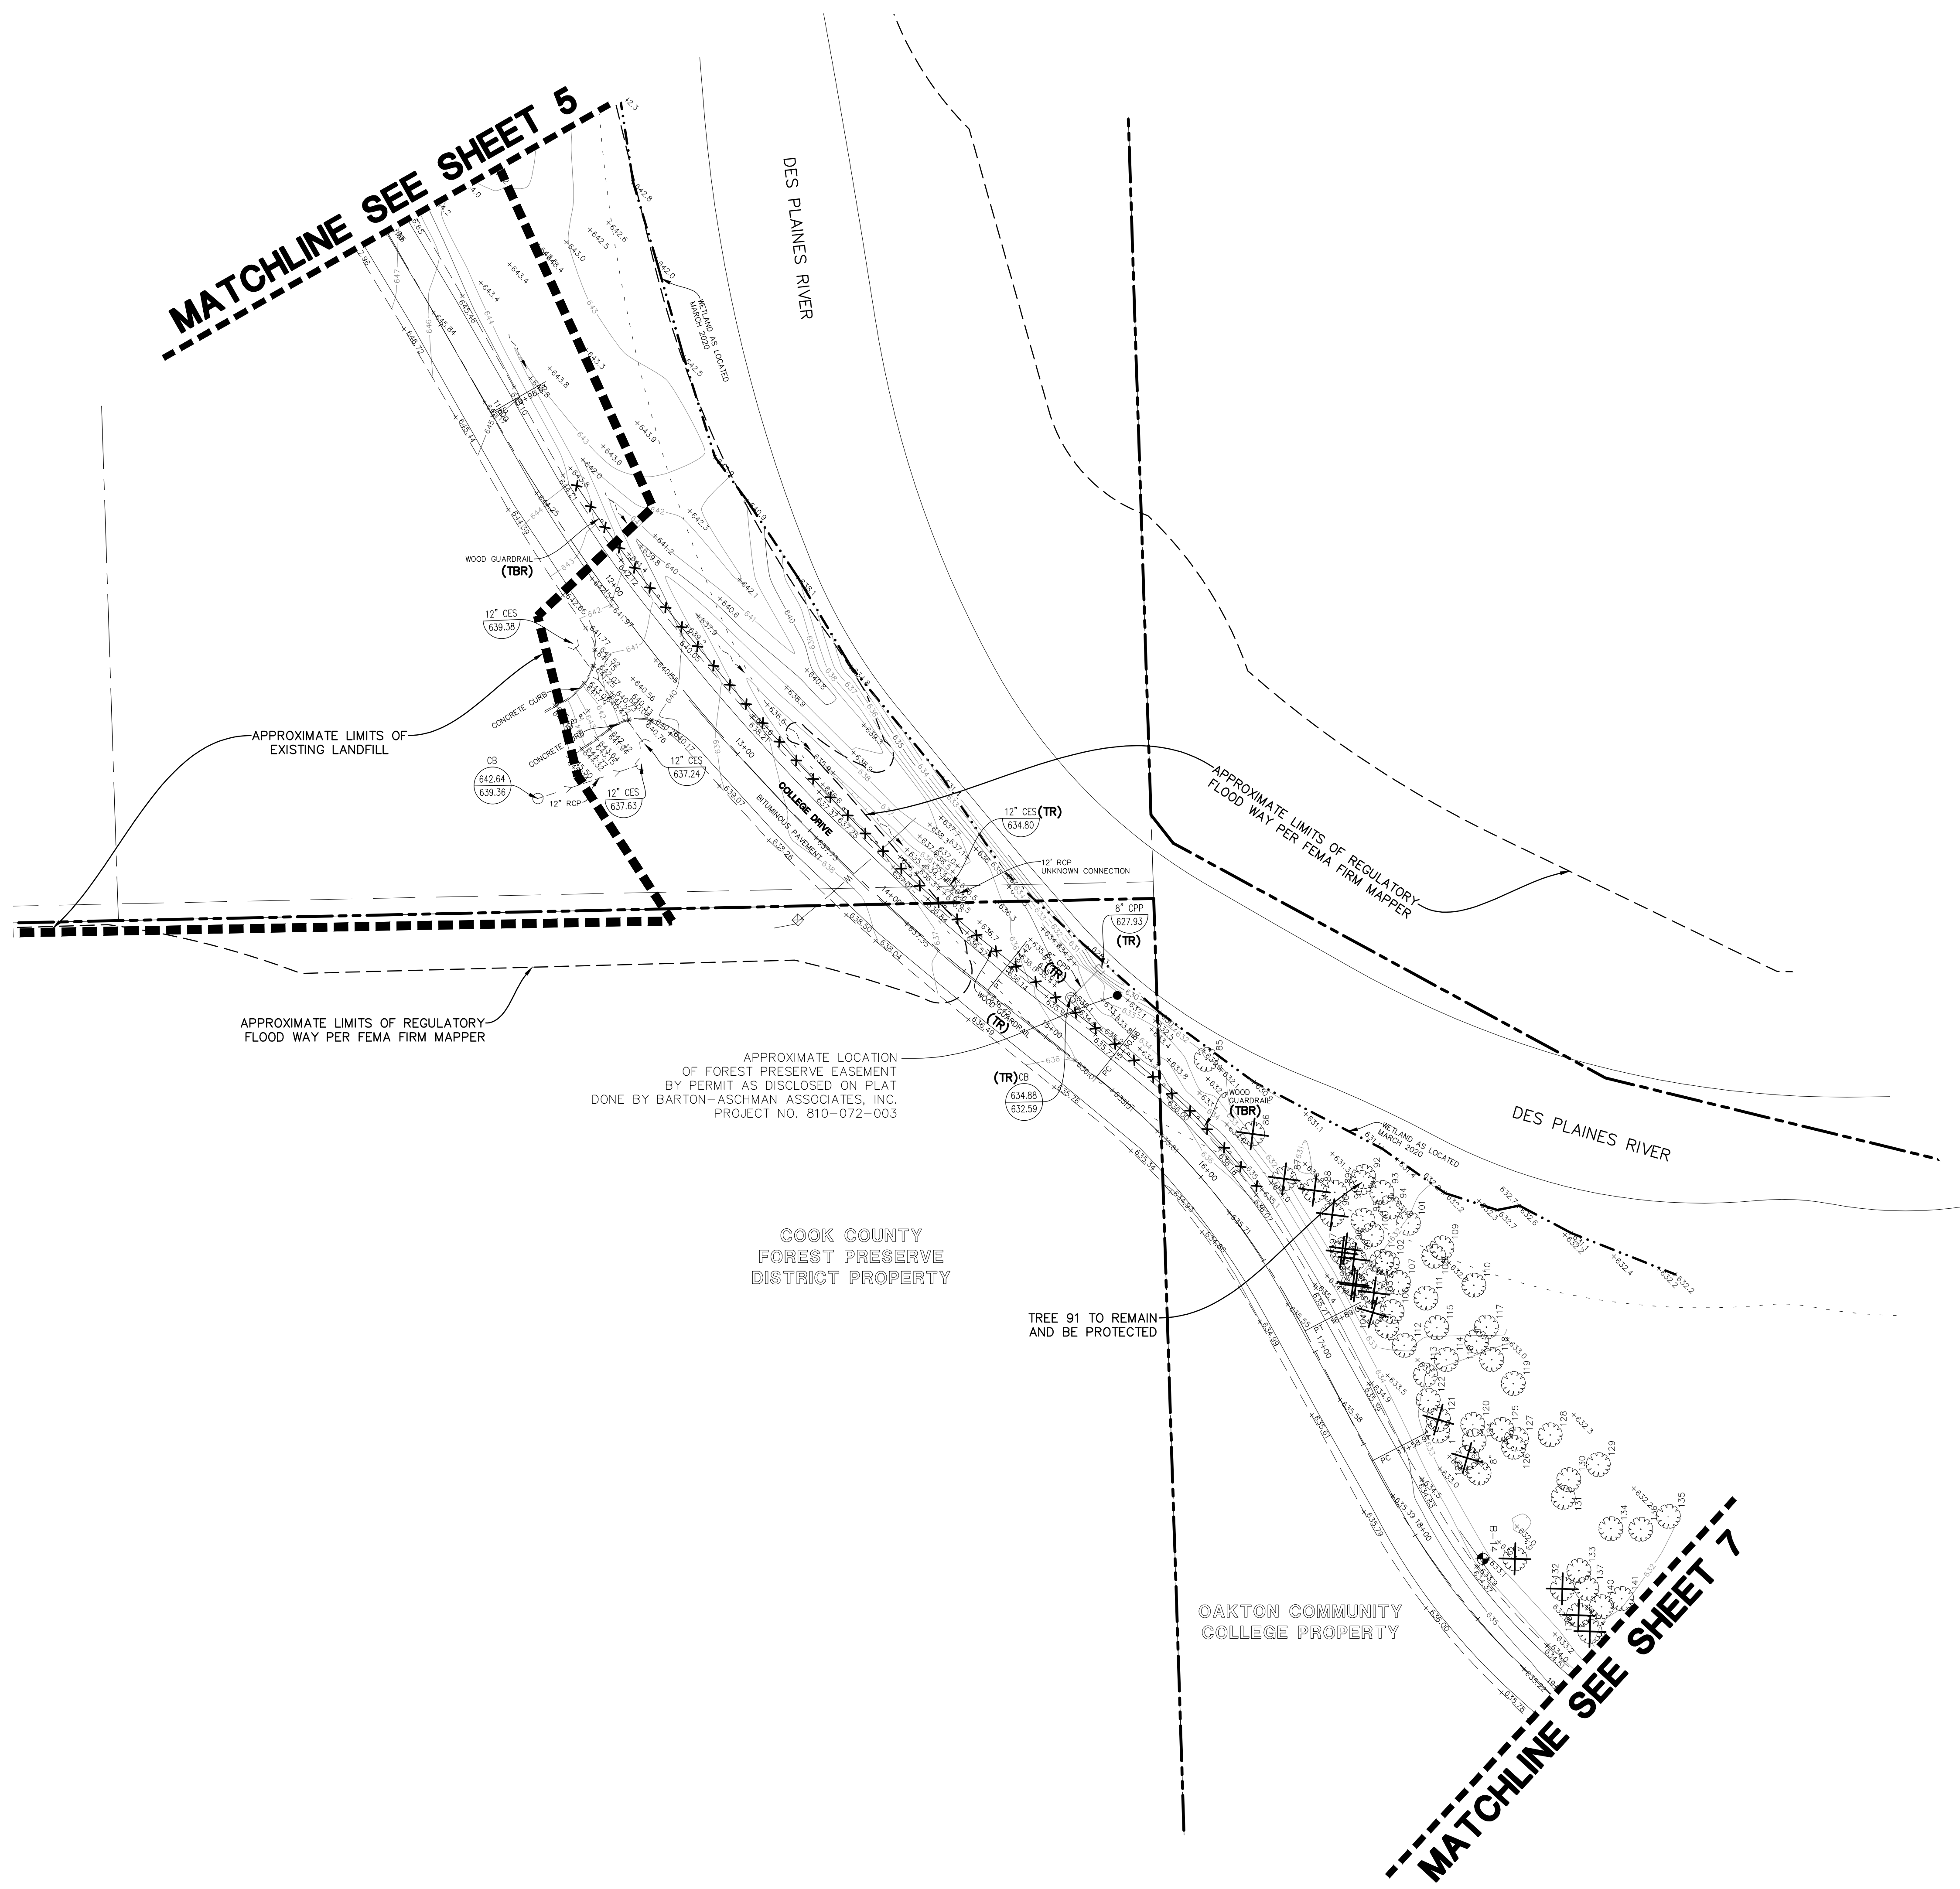

TAG #	SPECIES	NOTES
11		
13		
14		
22		
86	RED OAK	POOR CONDITION
90	BLACK CHERRY	
96	SUGAR MAPLE	
97	BLACK CHERRY	
98	BASSWOOD	
104	BLACK CHERRY	
121	AMERICAN ELM	
123	AMERICAN ELM	
132	SUGAR MAPLE	
138	SUGAR MAPLE	
139	SUGAR MAPLE	
142	AMERICAN ELM	
153	SUGAR MAPLE	
162	CATALPA	
163	AMERICAN ELM	
177?	AMERICAN ELM	POSSIBLY PRUNE AND KEEP
181	AMERICAN ELM	
182	BITTERNUT HICKORY	
192	SUGAR MAPLE	
193	RED OAK	
211	BASSWOOD	
219	SUGAR MAPLE	
220	SUGAR MAPLE	
221	RED OAK	
222	SUGAR MAPLE	
223	SUGAR MAPLE	
224	SUGAR MAPLE	
242	RED OAK	

DEMOLITION LEGEND	
	PAVEMENT AND BASE TO BE REMOVED
	FENCE, RETAINING WALL, RAILROAD TIES, POLES, CURB AND GUTTER, ETC. TO BE REMOVED
	UTILITY STRUCTURE TO BE REMOVED
	UTILITY LINE REMOVAL, FILL OR ABANDONMENT (REFER TO SPECIFICATIONS)
	TREE TO BE REMOVED
(TBR)	TO BE REMOVED
(TR)	TO REMAIN

EXISTING CONDITIONS AND DEMOLITION NOTES:

- EXISTING CONDITIONS AND DEMOLITION PLAN REPRESENT SITE CONDITIONS AS OF APRIL 02, 2020. CONTRACTOR SHALL INSPECT SITE PRIOR TO BIDDING WORK TO VERIFY ACTUAL FIELD CONDITIONS AS PORTIONS OF THE DEMOLITION WORK MAY HAVE SINCE BEEN COMPLETED. CONTRACTOR SHALL BE RESPONSIBLE TO COMPLETE ALL DEMOLITION WORK AS PER PLANS TO PREPARE THE SITE FOR CONSTRUCTION OF PROPOSED IMPROVEMENTS.
- THE UNDERGROUND UTILITY INFORMATION AS SHOWN HEREON IS BASED, IN PART, UPON INFORMATION FURNISHED BY UTILITY COMPANIES AND THE LOCAL MUNICIPALITY. WHILE THIS INFORMATION IS BELIEVED TO BE RELIABLE, ITS ACCURACY AND COMPLETENESS CANNOT BE GUARANTEED NOR CERTIFIED TO.
- THE CONTRACTOR IS RESPONSIBLE FOR DEMOLITION, REMOVAL AND DISPOSAL (IN A LOCATION APPROVED BY ALL JURISDICTIONAL GOVERNING ENTITIES) OF ALL STRUCTURES, PADS, WALLS, FLUMES, FOUNDATIONS, ROAD, PARKING LOTS, DRIVES, DRAINAGE STRUCTURES, UTILITIES, ETC., SUCH THAT THE IMPROVEMENTS SHOWN ON THESE PLANS CAN BE CONSTRUCTED. ALL DEMOLITION WORK SHALL BE IN ACCORDANCE WITH ALL APPLICABLE FEDERAL, STATE AND LOCAL REQUIREMENTS. ALL FACILITIES TO BE REMOVED SHALL BE UNDERCUT TO SUITABLE MATERIAL AND BROUGHT TO GRADE WITH SUITABLE COMPACTED FILL MATERIAL PER THE SPECIFICATIONS.
- REFER TO SPECIFICATIONS SHEET FOR DEMOLITION NOTES.

DATE	REVISIONS
01-19-22	REVISED FOR METAL CABLE GAUDBRILL
11-10-21	ISSUED FOR BIDS

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PEDESTRIAN AND BICYCLE PATHWAY
 OAKTON COMMUNITY COLLEGE - DES PLAINES CAMPUS
 DEMOLITION PLAN - CENTER

PROJ. MGR.: DBM
 PROJ. ASSOC.: JWS
 DRAWN BY: REH
 DATE: 05-04-21
 SCALE: 1"=40'


SHEET
6 OF 30
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December 21, 2022 - 09:53 Draw Name: c:\occdp10\Draws\Final\Drawings\Plan Set\05-07-DEMOC.dwg. Updated By: Wjw

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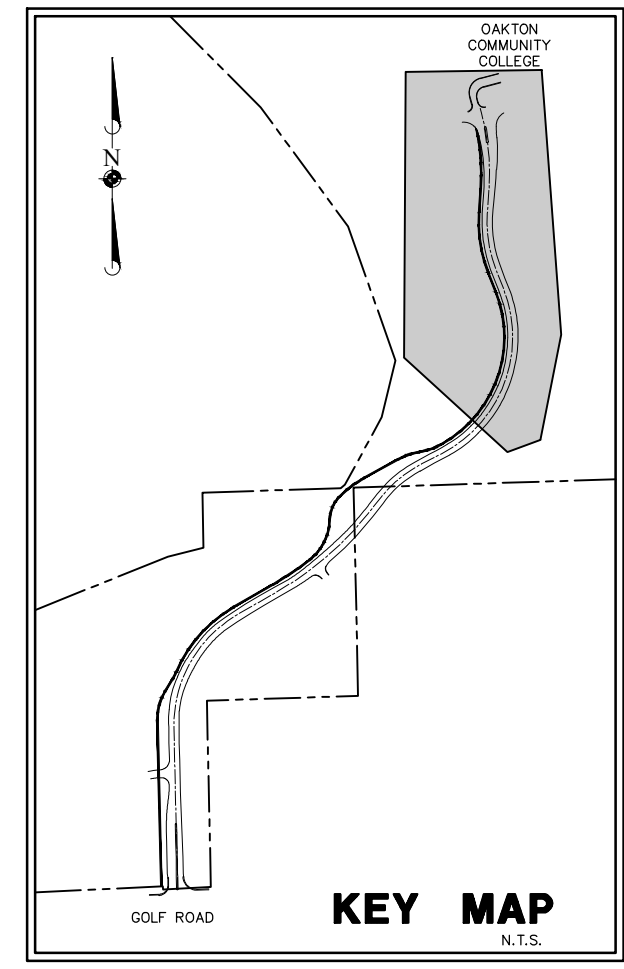
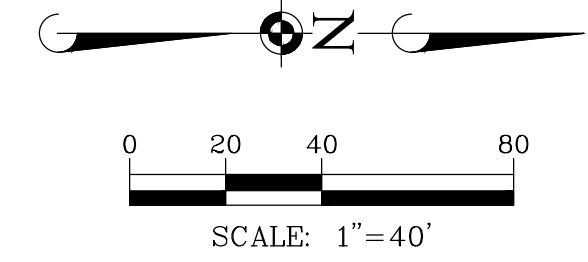
ISSUED FOR BID

TAG #	SPECIES	NOTES
11		
13		
14		
22		
86	RED OAK	POOR CONDITION
90	BLACK CHERRY	
96	SUGAR MAPLE	
97	BLACK CHERRY	
98	BASSWOOD	
104	BLACK CHERRY	
121	AMERICAN ELM	
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192	SUGAR MAPLE	
193	RED OAK	
211	BASSWOOD	
219	SUGAR MAPLE	
220	SUGAR MAPLE	
221	RED OAK	
222	SUGAR MAPLE	
223	SUGAR MAPLE	
224	SUGAR MAPLE	
242	RED OAK	



06-01-16 EXISTING CONDITIONS AND DEMOLITION NOTES:

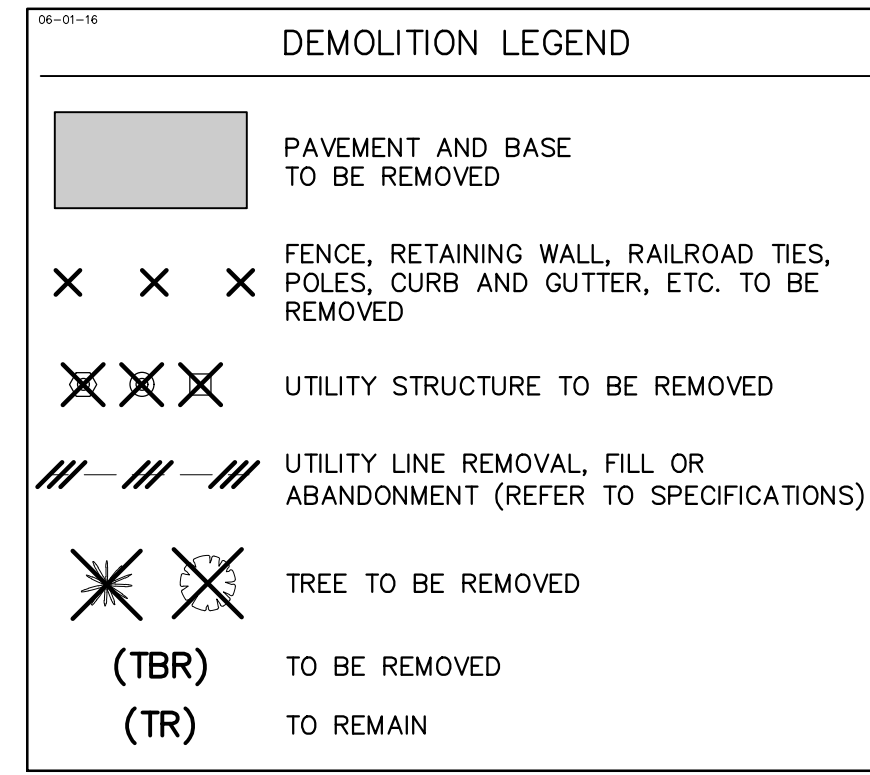
- EXISTING CONDITIONS AND DEMOLITION PLAN REPRESENT SITE CONDITIONS AS OF APRIL 02, 2020. CONTRACTOR SHALL INSPECT SITE PRIOR TO BIDDING WORK TO VERIFY ACTUAL FIELD CONDITIONS AS PORTIONS OF THE DEMOLITION WORK MAY HAVE SINCE BEEN COMPLETED. CONTRACTOR SHALL BE RESPONSIBLE TO COMPLETE ALL DEMOLITION WORK AS PER PLANS TO PREPARE THE SITE FOR CONSTRUCTION OF PROPOSED IMPROVEMENTS.
- THE UNDERGROUND UTILITY INFORMATION AS SHOWN HEREON IS BASED, IN PART, UPON INFORMATION FURNISHED BY UTILITY COMPANIES AND THE LOCAL MUNICIPALITY. WHILE THIS INFORMATION IS BELIEVED TO BE RELIABLE, ITS ACCURACY AND COMPLETENESS CANNOT BE GUARANTEED NOR CERTIFIED TO.
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- REFER TO SPECIFICATIONS SHEET FOR DEMOLITION NOTES.



DATE	REVISIONS	ISSUED FOR BIDS
		11-10-21

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MATCHLINE SEE SHEET 6

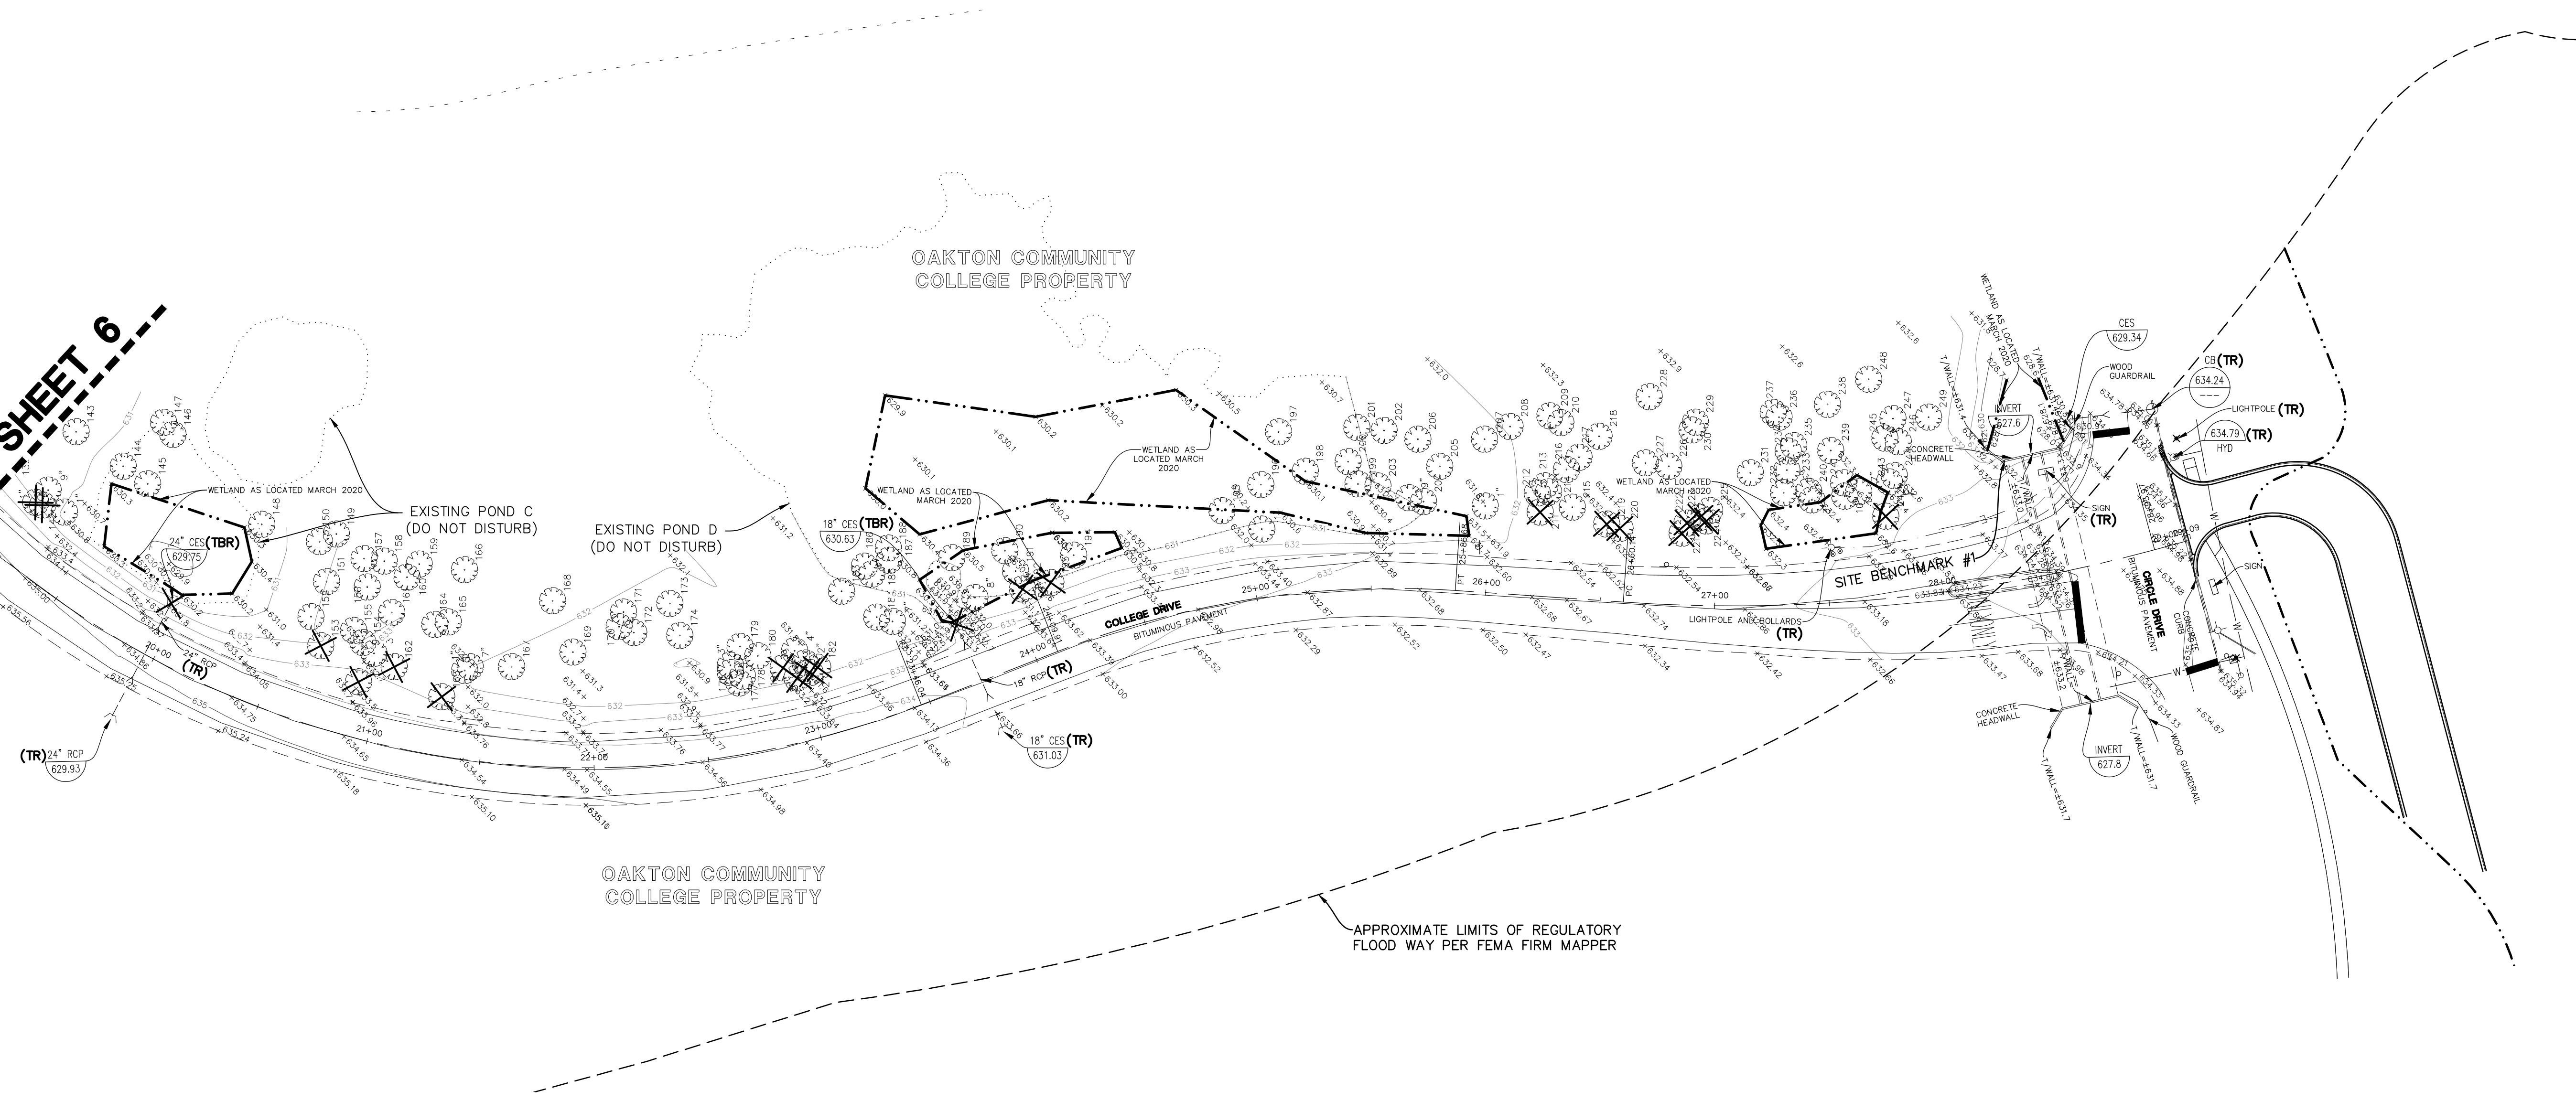


PEDESTRIAN AND BICYCLE PATHWAY
 OAKTON COMMUNITY COLLEGE - DES PLAINES CAMPUS
 DEMOLITION PLAN - NORTH

PROJ. MGR.: DBM
 PROJ. ASSOC.: JWS
 DRAWN BY: REH
 DATE: 05-04-21
 SCALE: 1"=40'
 SHEET
7 OF **30**
 OCCDPIL10


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ISSUED FOR BID



PEDESTRIAN AND BICYCLE PATHWAY ALONG COLLEGE DRIVE

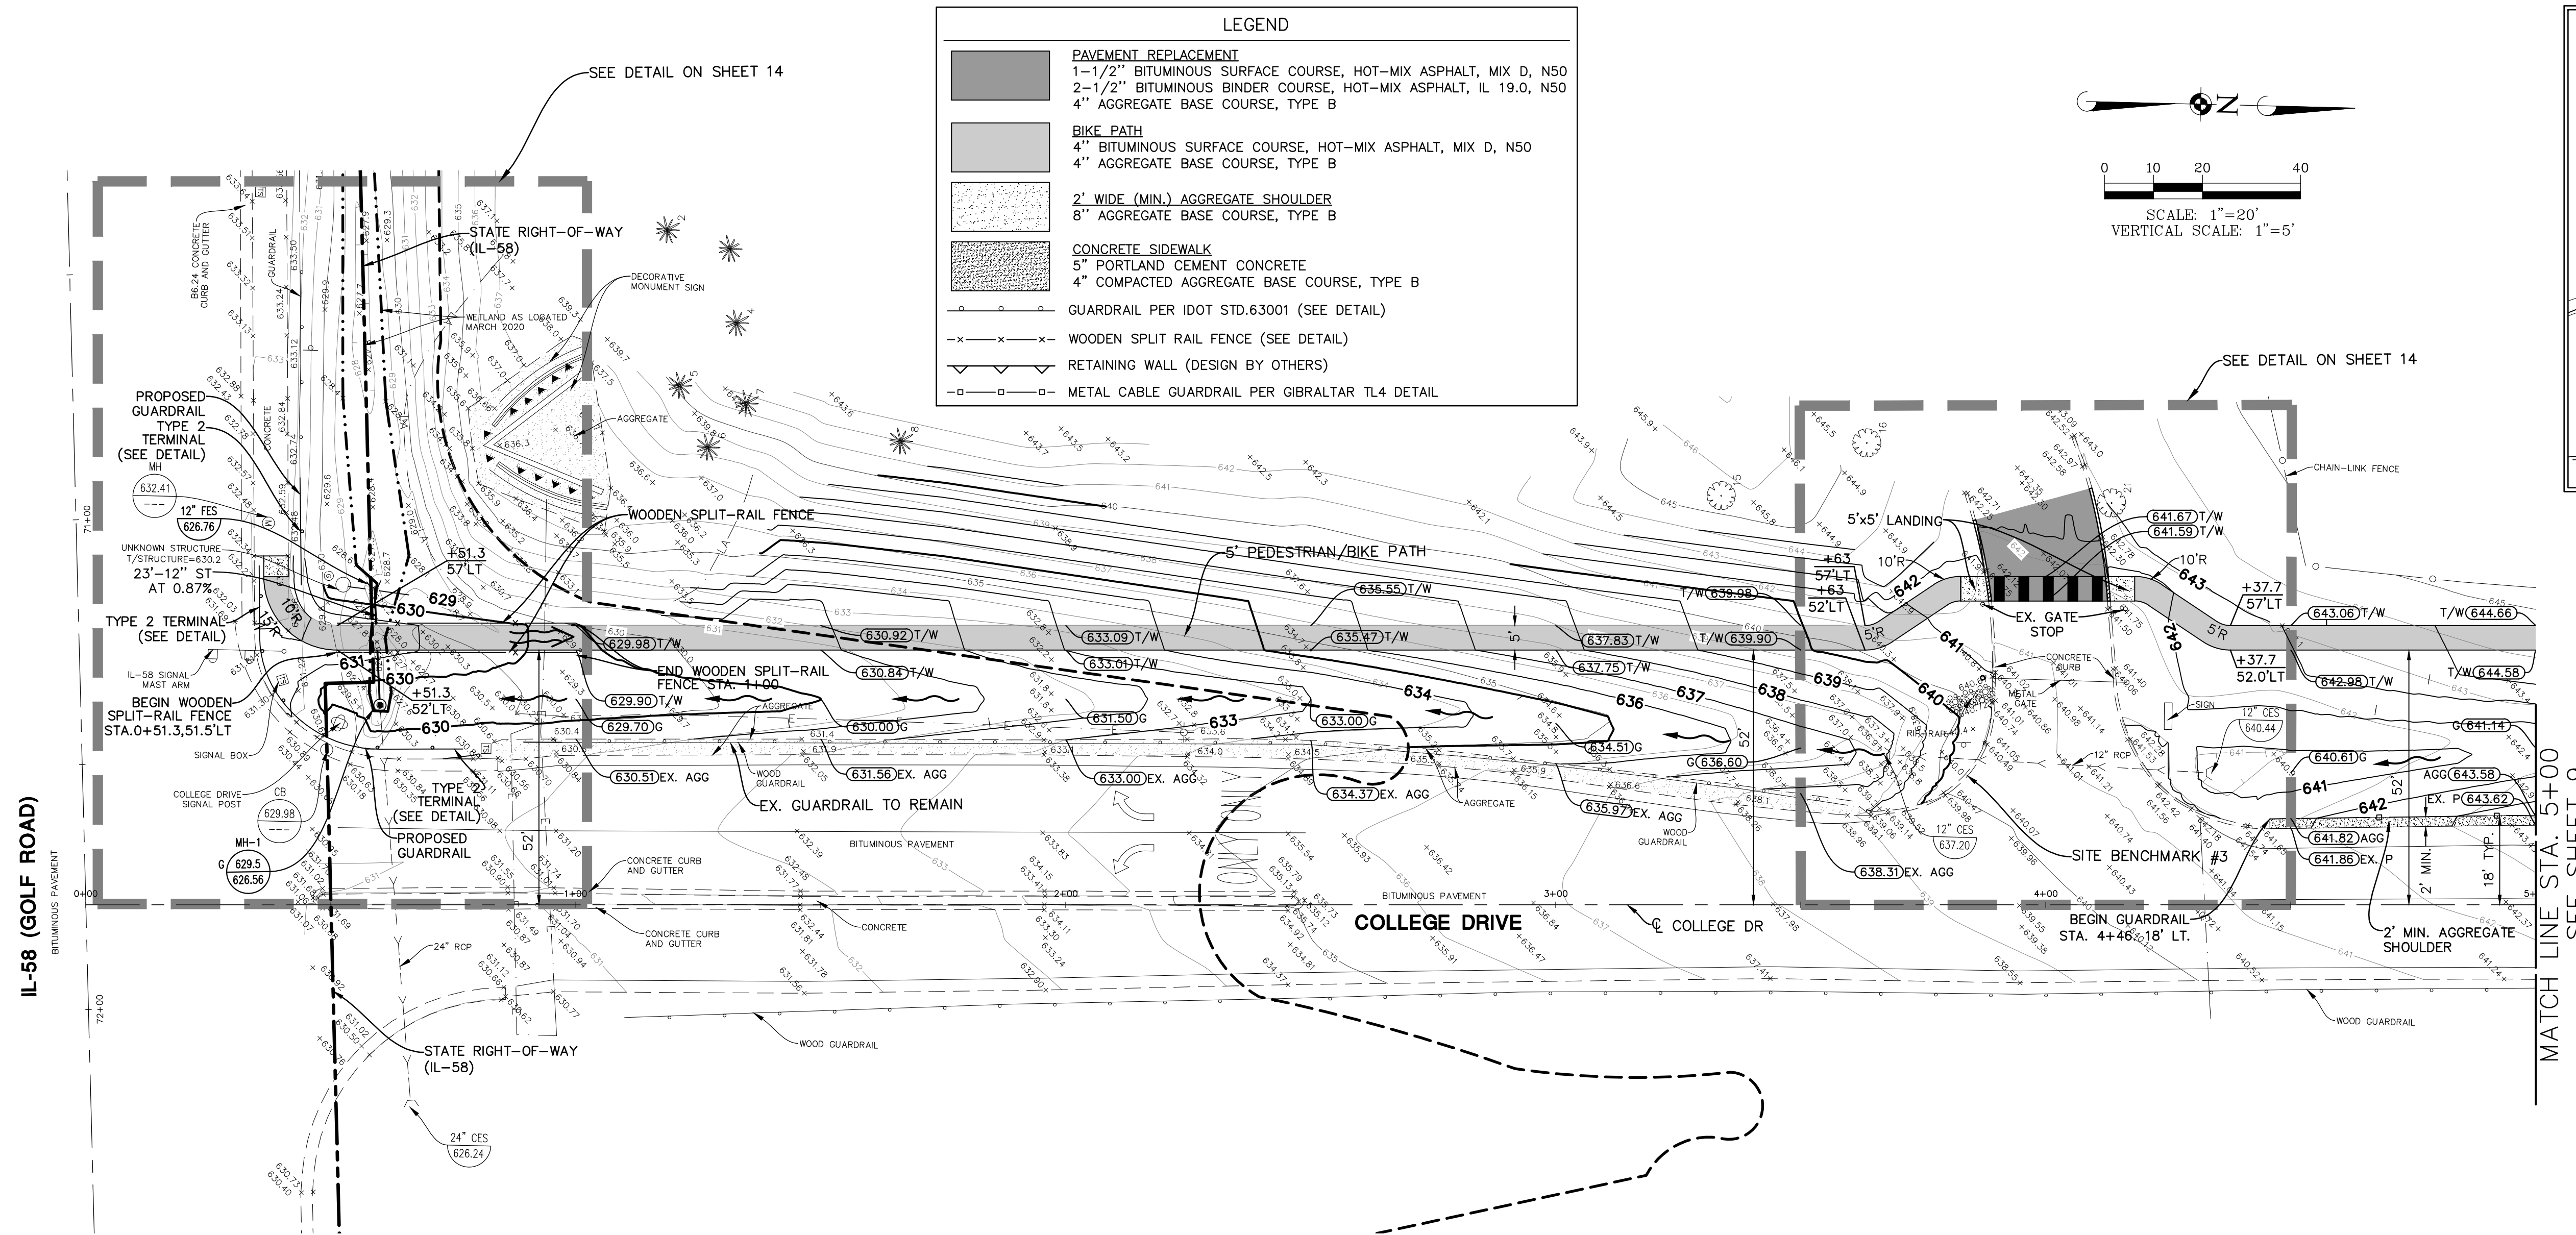

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 Construction Managers • Environmental Scientists • Planners




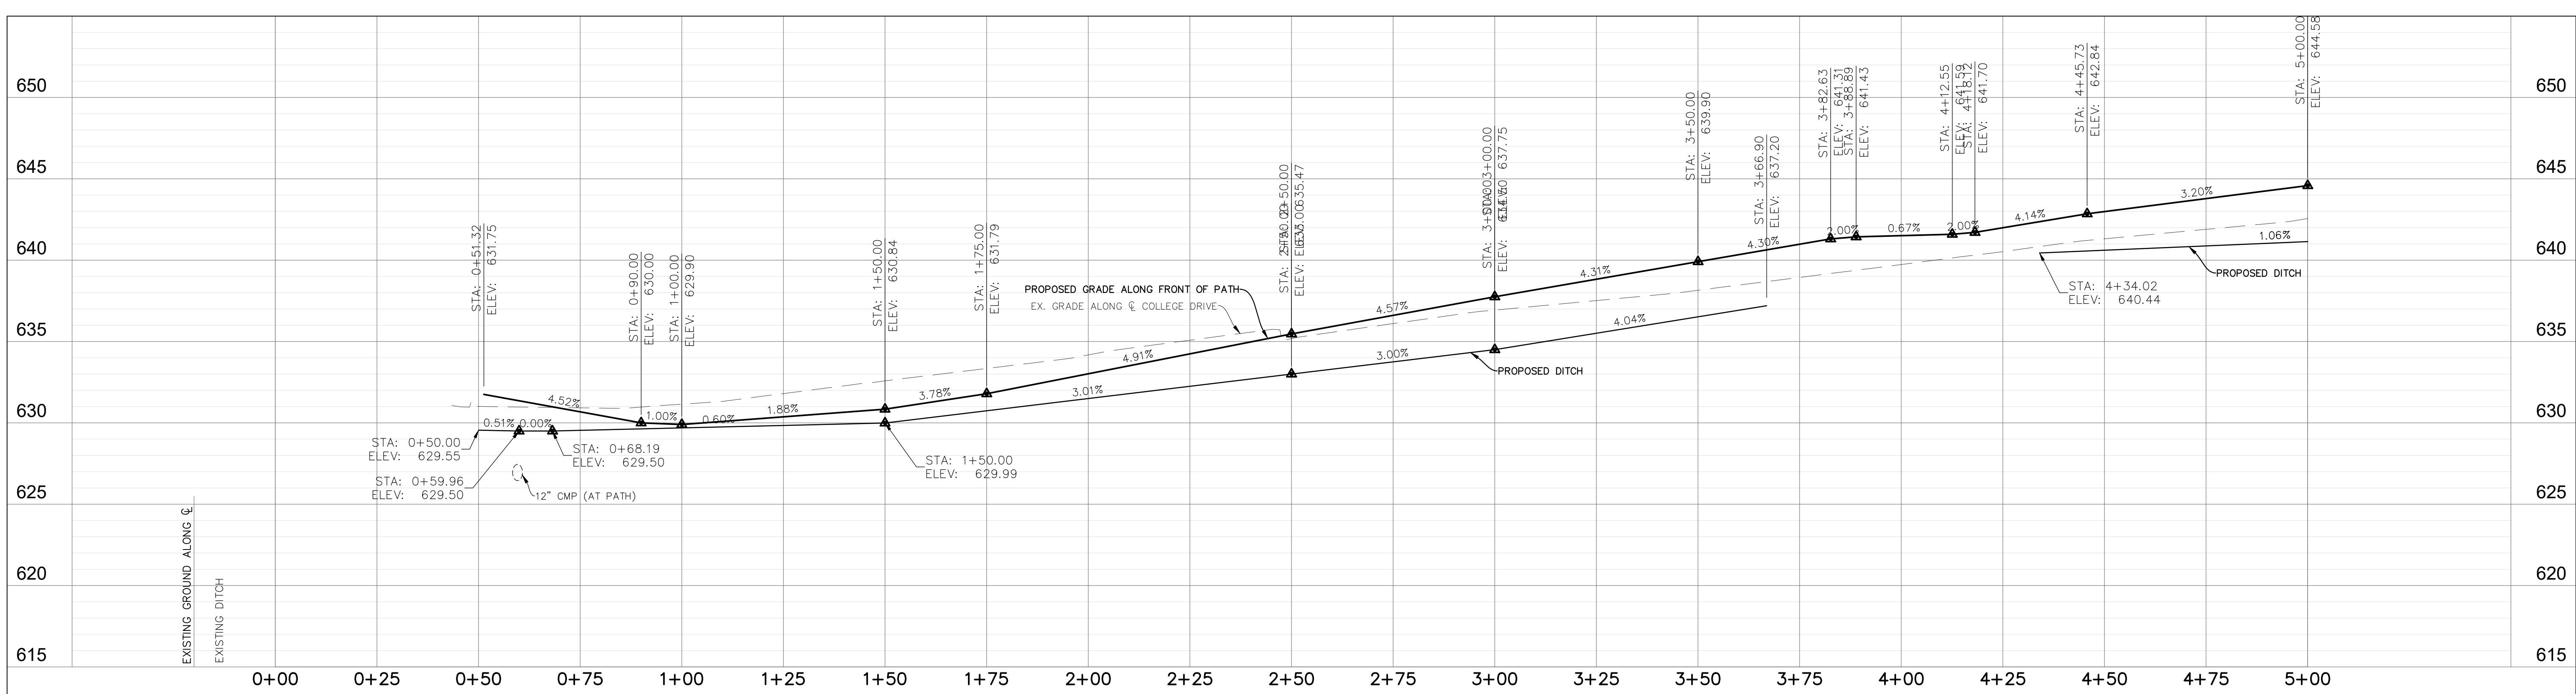
PEDESTRIAN AND BICYCLE PATHWAY
OAKTON COMMUNITY COLLEGE - DES PLAINES CAMPUS
PLAN AND PROFILE - COLLEGE DRIVE STA. 0+00 TO 5+00

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 PROJ. ASSOC.: JWS
 DRAWN BY: REH
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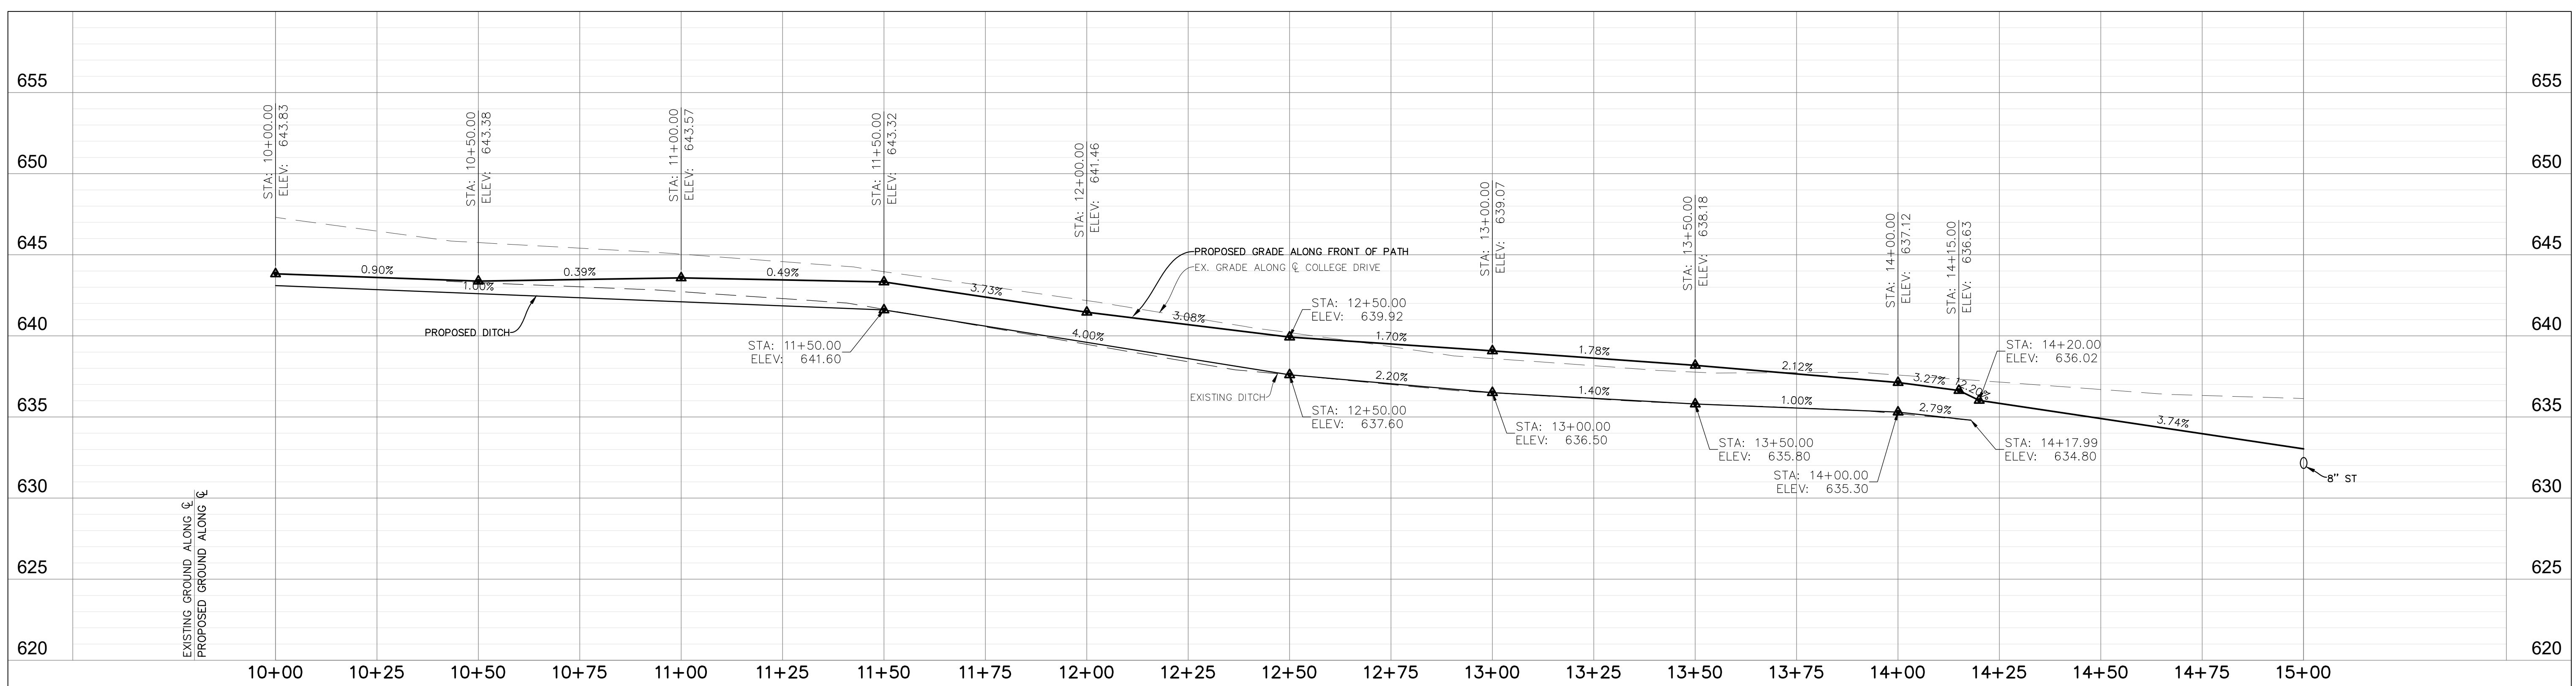
SHEET
8 OF 30
 OCCDPIL10

ISSUED FOR BID

LEGEND	
PAVEMENT REPLACEMENT	
	1-1/2" BITUMINOUS SURFACE COURSE, HOT-MIX ASPHALT, MIX D, N50
	2-1/2" BITUMINOUS BINDER COURSE, HOT-MIX ASPHALT, IL 19.0, N50
	4" AGGREGATE BASE COURSE, TYPE B
BIKE PATH	
	4" BITUMINOUS SURFACE COURSE, HOT-MIX ASPHALT, MIX D, N50
	4" AGGREGATE BASE COURSE, TYPE B
2' WIDE (MIN.) AGGREGATE SHOULDER	
	2" AGGREGATE BASE COURSE, TYPE B
CONCRETE SIDEWALK	
	5" PORTLAND CEMENT CONCRETE
	4" COMPACTED AGGREGATE BASE COURSE, TYPE B
	GUARDRAIL PER IDOT STD.63001 (SEE DETAIL)
	WOODEN SPLIT RAIL FENCE (SEE DETAIL)
	RETAINING WALL (DESIGN BY OTHERS)
	METAL CABLE GUARDRAIL PER GIBRALTAR TL4 DETAIL

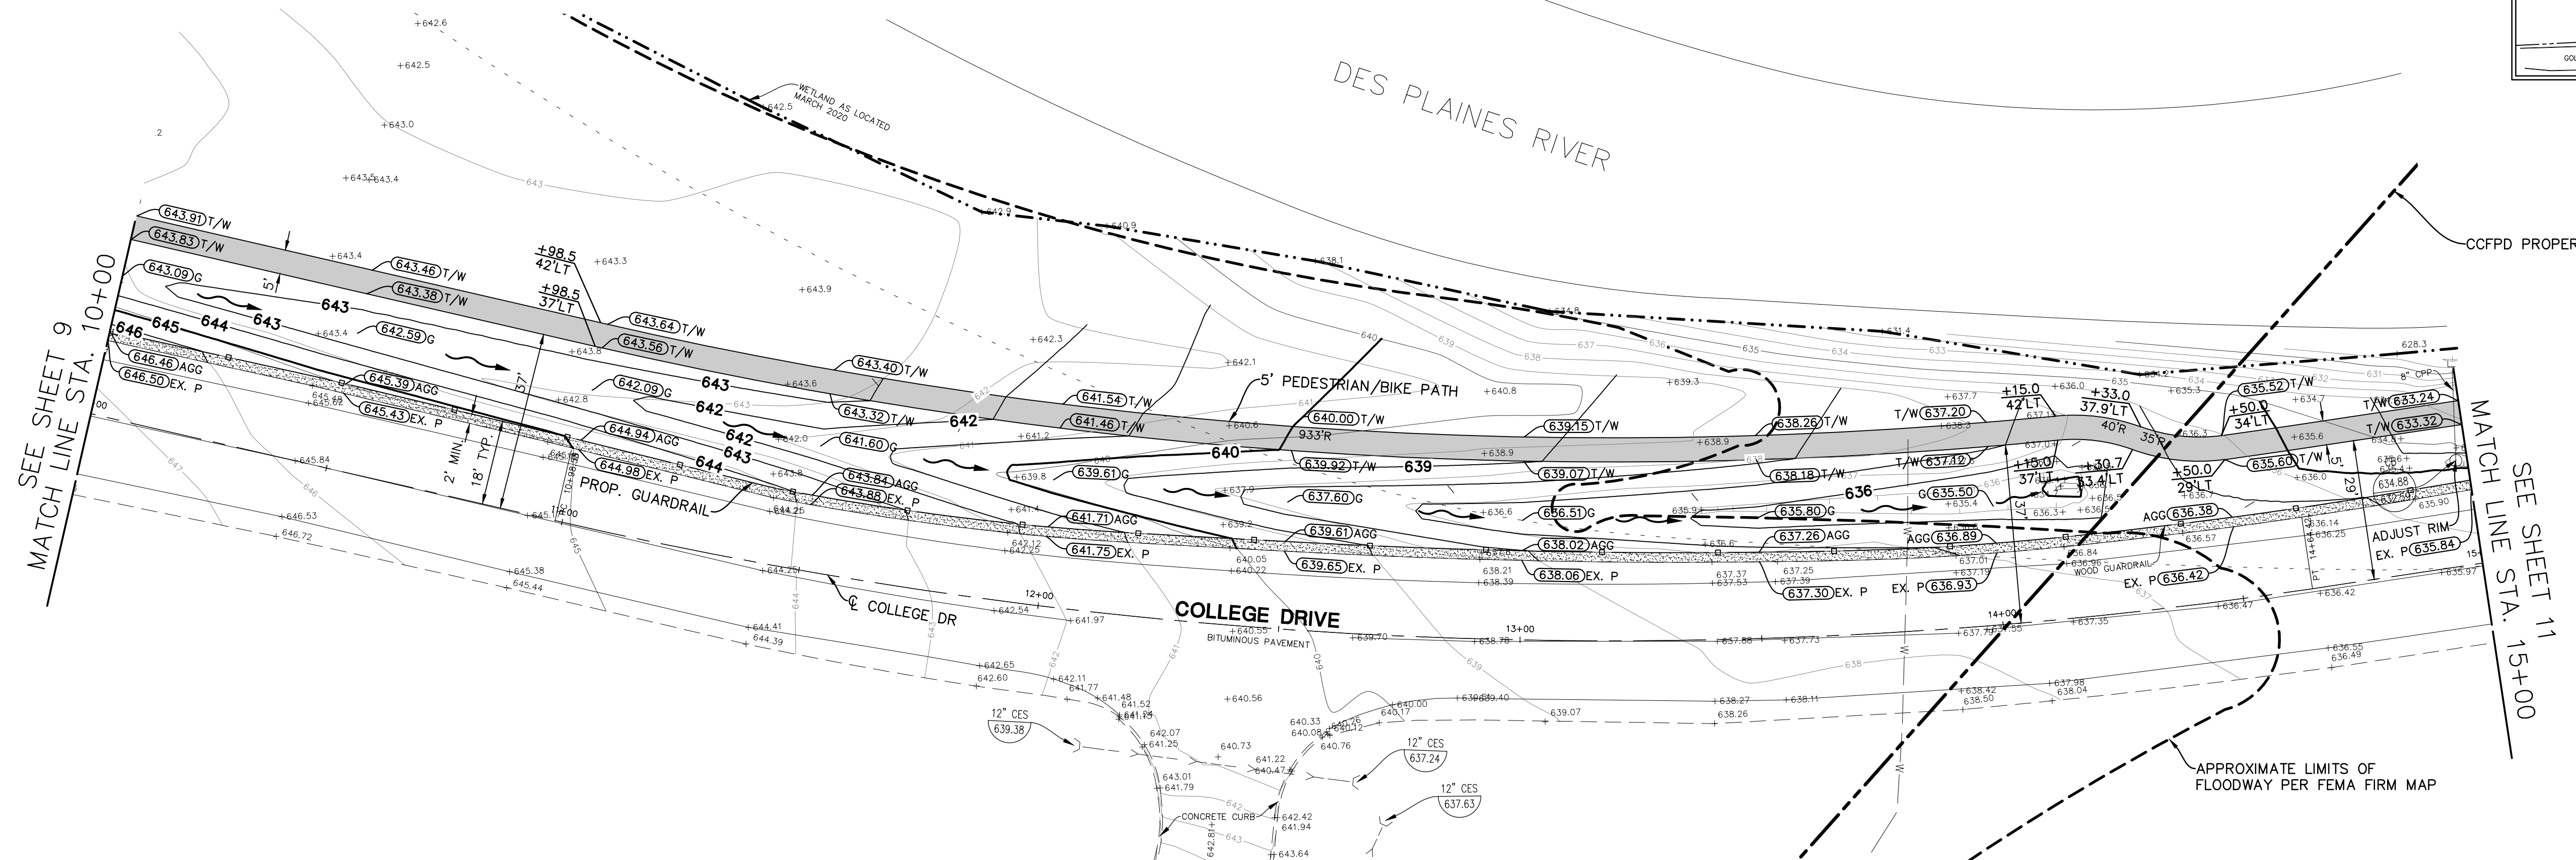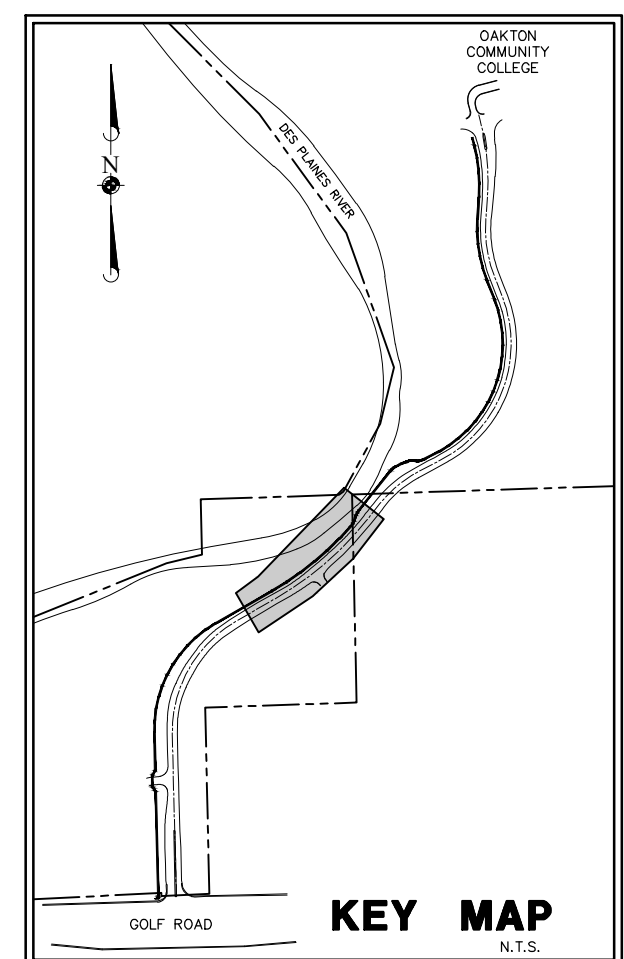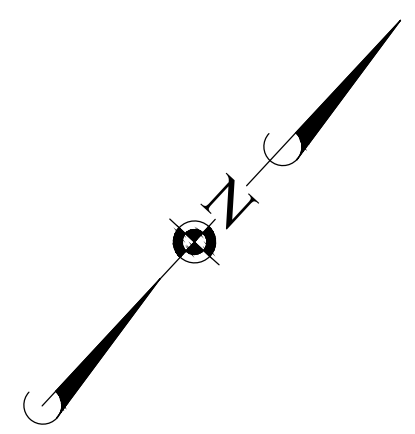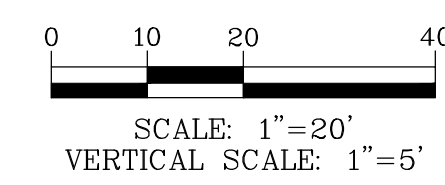

PEDESTRIAN AND BICYCLE PATHWAY ALONG COLLEGE DRIVE



DATE	REVISIONS
12-21-22	REVISED FOR BIDS
10-23-22	REVISED FOR BIDS
02-09-22	FINAL BID SET
01-19-22	REVISED FOR METAL CABLE GUARDRAIL
11-10-21	ISSUED FOR BIDS

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 Construction Managers • Environmental Scientists • Planners

PEDESTRIAN AND BICYCLE PATHWAY
OAKTON COMMUNITY COLLEGE - DES PLAINES CAMPUS
PLAN AND PROFILE - COLLEGE DRIVE STA. 10+00 TO 15+00




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PROJ. ASSOC.:	JWS
DRAWN BY:	REH
DATE:	05-04-21
SCALE:	H:1"=20' V:1"=5'
SHEET	10 OF 30
	OCCDPIL10

December 21, 2022 - 10:19 Draw Name: g:\occdp\10\Oakton\Drawings\Plan_Sht_V08-13-P&P.dwg Updated By: Whom

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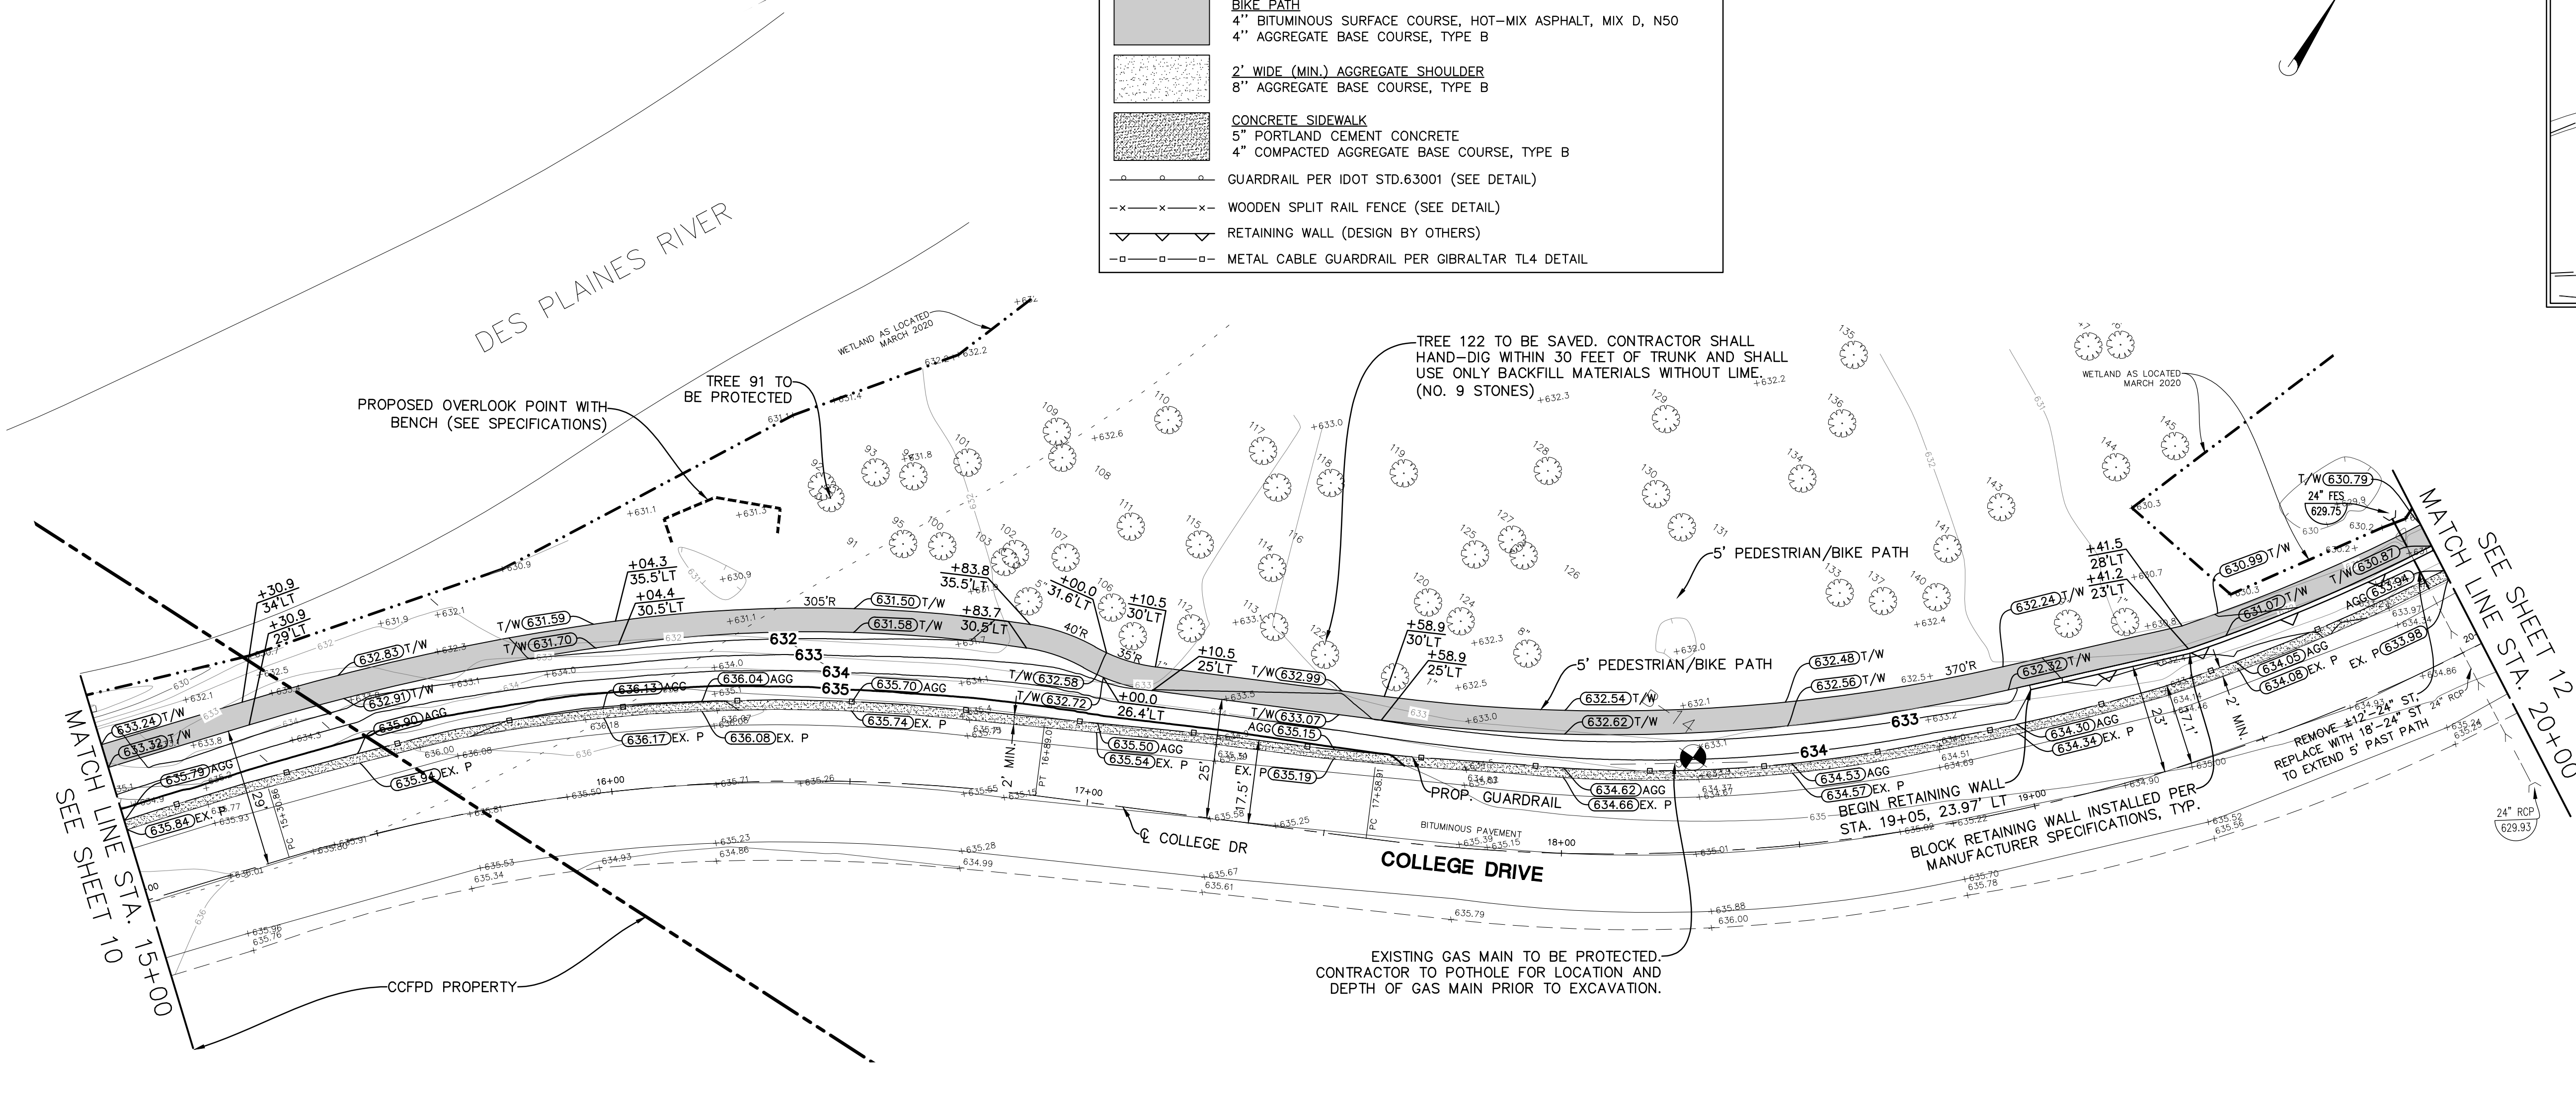
ISSUED FOR BID

LEGEND	
	PAVEMENT REPLACEMENT 1-1/2" BITUMINOUS SURFACE COURSE, HOT-MIX ASPHALT, MIX D, N50 2-1/2" BITUMINOUS BINDER COURSE, HOT-MIX ASPHALT, IL 19.0, N50 4" AGGREGATE BASE COURSE, TYPE B
	BIKE PATH 4" BITUMINOUS SURFACE COURSE, HOT-MIX ASPHALT, MIX D, N50 4" AGGREGATE BASE COURSE, TYPE B
	2' WIDE (MIN.) AGGREGATE SHOULDER 8" AGGREGATE BASE COURSE, TYPE B
	CONCRETE SIDEWALK 5" PORTLAND CEMENT CONCRETE 4" COMPACTED AGGREGATE BASE COURSE, TYPE B
	GUARDRAIL PER IDOT STD. 63001 (SEE DETAIL)
	WOODEN SPLIT RAIL FENCE (SEE DETAIL)
	RETAINING WALL (DESIGN BY OTHERS)
	METAL CABLE GUARDRAIL PER GIBRALTAR TL4 DETAIL

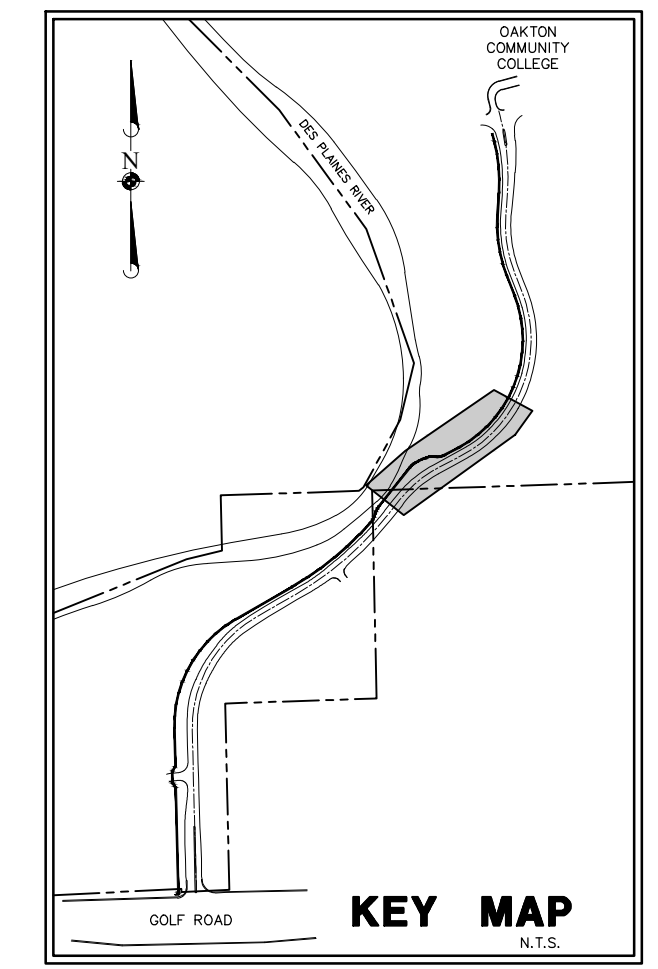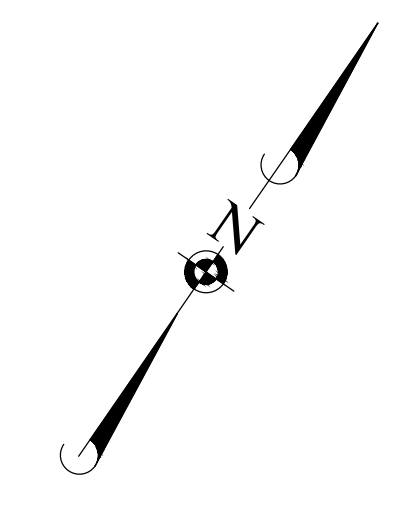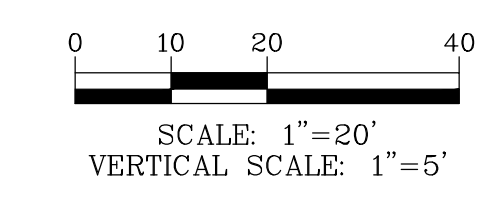


DATE	REVISIONS
02-09-23	FINAL BID SET
01-19-22	REVISED FOR METAL CABLE GUARDRAIL
11-10-20	ISSUED FOR BIDS

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 Construction Managers • Environmental Scientists • Landscape Architects • Planners



PEDESTRIAN AND BICYCLE PATHWAY ALONG COLLEGE DRIVE

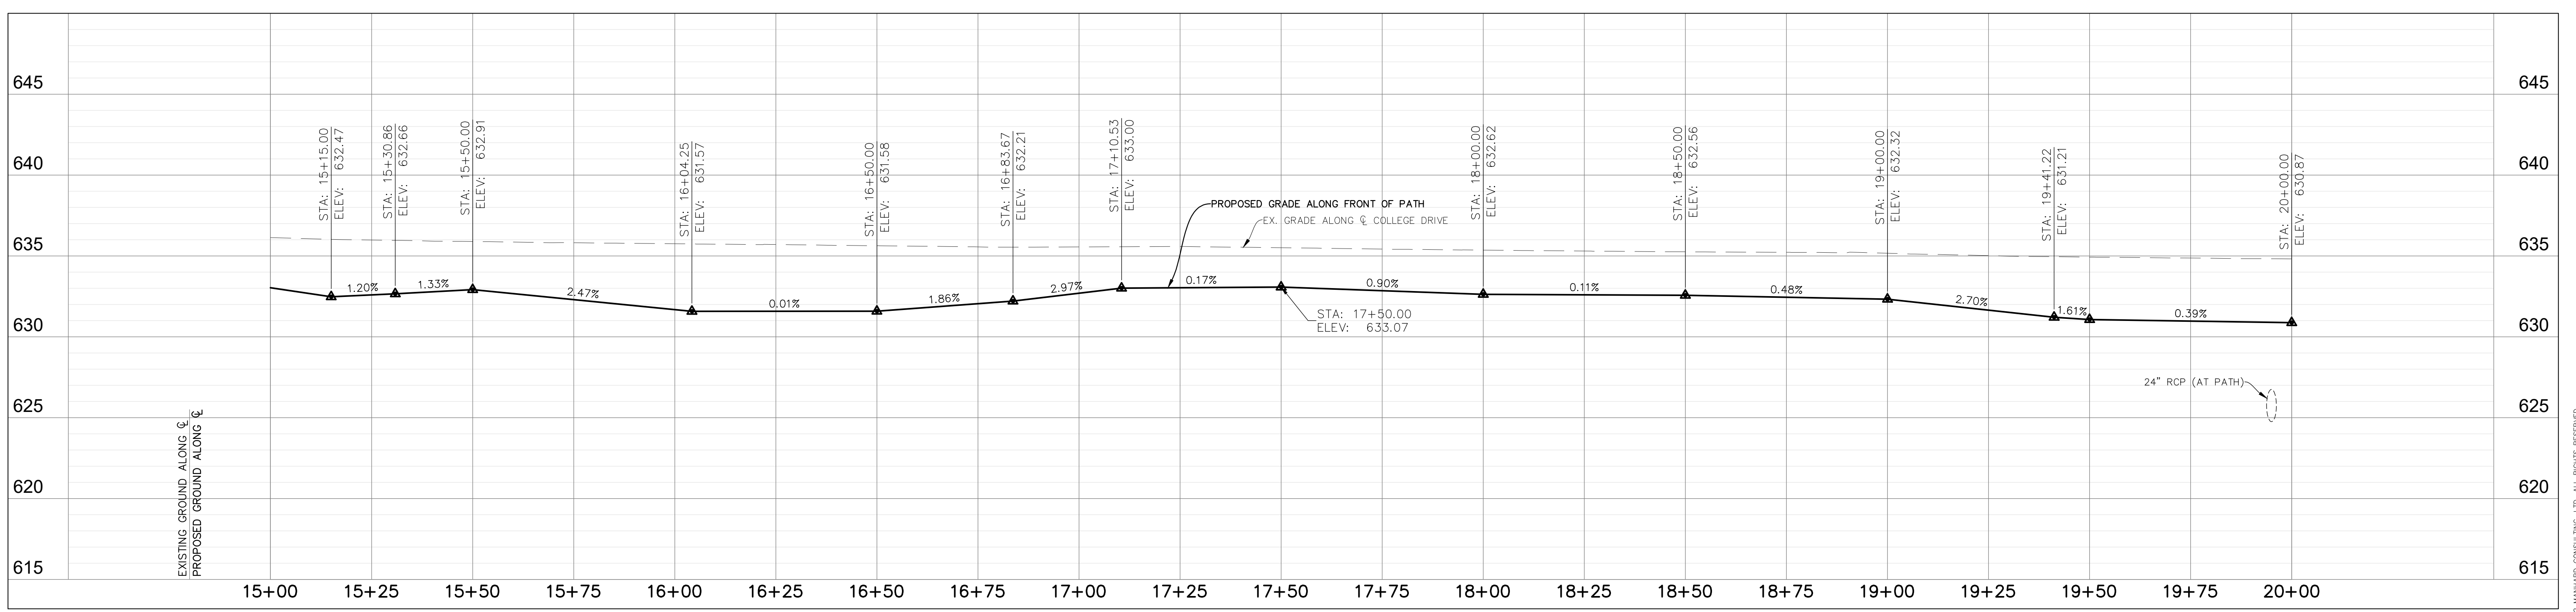

December 21, 2022 - 10:19 Draw Name: g:\occdp\10\Man\Final\Drawings\Plan_Sht\108-13-P&P.dwg Updated By: Whom

PEDESTRIAN AND BICYCLE PATHWAY
OAKTON COMMUNITY COLLEGE - DES PLAINES CAMPUS
PLAN AND PROFILE - COLLEGE DRIVE STA. 15+00 TO 20+00




PROJ. MGR.: DBM
 PROJ. ASSOC.: JWS
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 SCALE: H: 1"=20' V: 1"=5'

SHEET
11 OF 30
 OCCDP110


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ISSUED FOR BID

LEGEND	
	PAVEMENT REPLACEMENT 1-1/2" BITUMINOUS SURFACE COURSE, HOT-MIX ASPHALT, MIX D, N50 2-1/2" BITUMINOUS BINDER COURSE, HOT-MIX ASPHALT, IL 19.0, N50 4" AGGREGATE BASE COURSE, TYPE B
	BIKE PATH 4" BITUMINOUS SURFACE COURSE, HOT-MIX ASPHALT, MIX D, N50 4" AGGREGATE BASE COURSE, TYPE B
	2' WIDE (MIN.) AGGREGATE SHOULDER 8" AGGREGATE BASE COURSE, TYPE B
	CONCRETE SIDEWALK 5" PORTLAND CEMENT CONCRETE 4" COMPACTED AGGREGATE BASE COURSE, TYPE B
	GUARDRAIL PER IDOT STD. 63001 (SEE DETAIL)
	WOODEN SPLIT RAIL FENCE (SEE DETAIL)
	RETAINING WALL (DESIGN BY OTHERS)
	METAL CABLE GUARDRAIL PER GIBRALTAR TL4 DETAIL

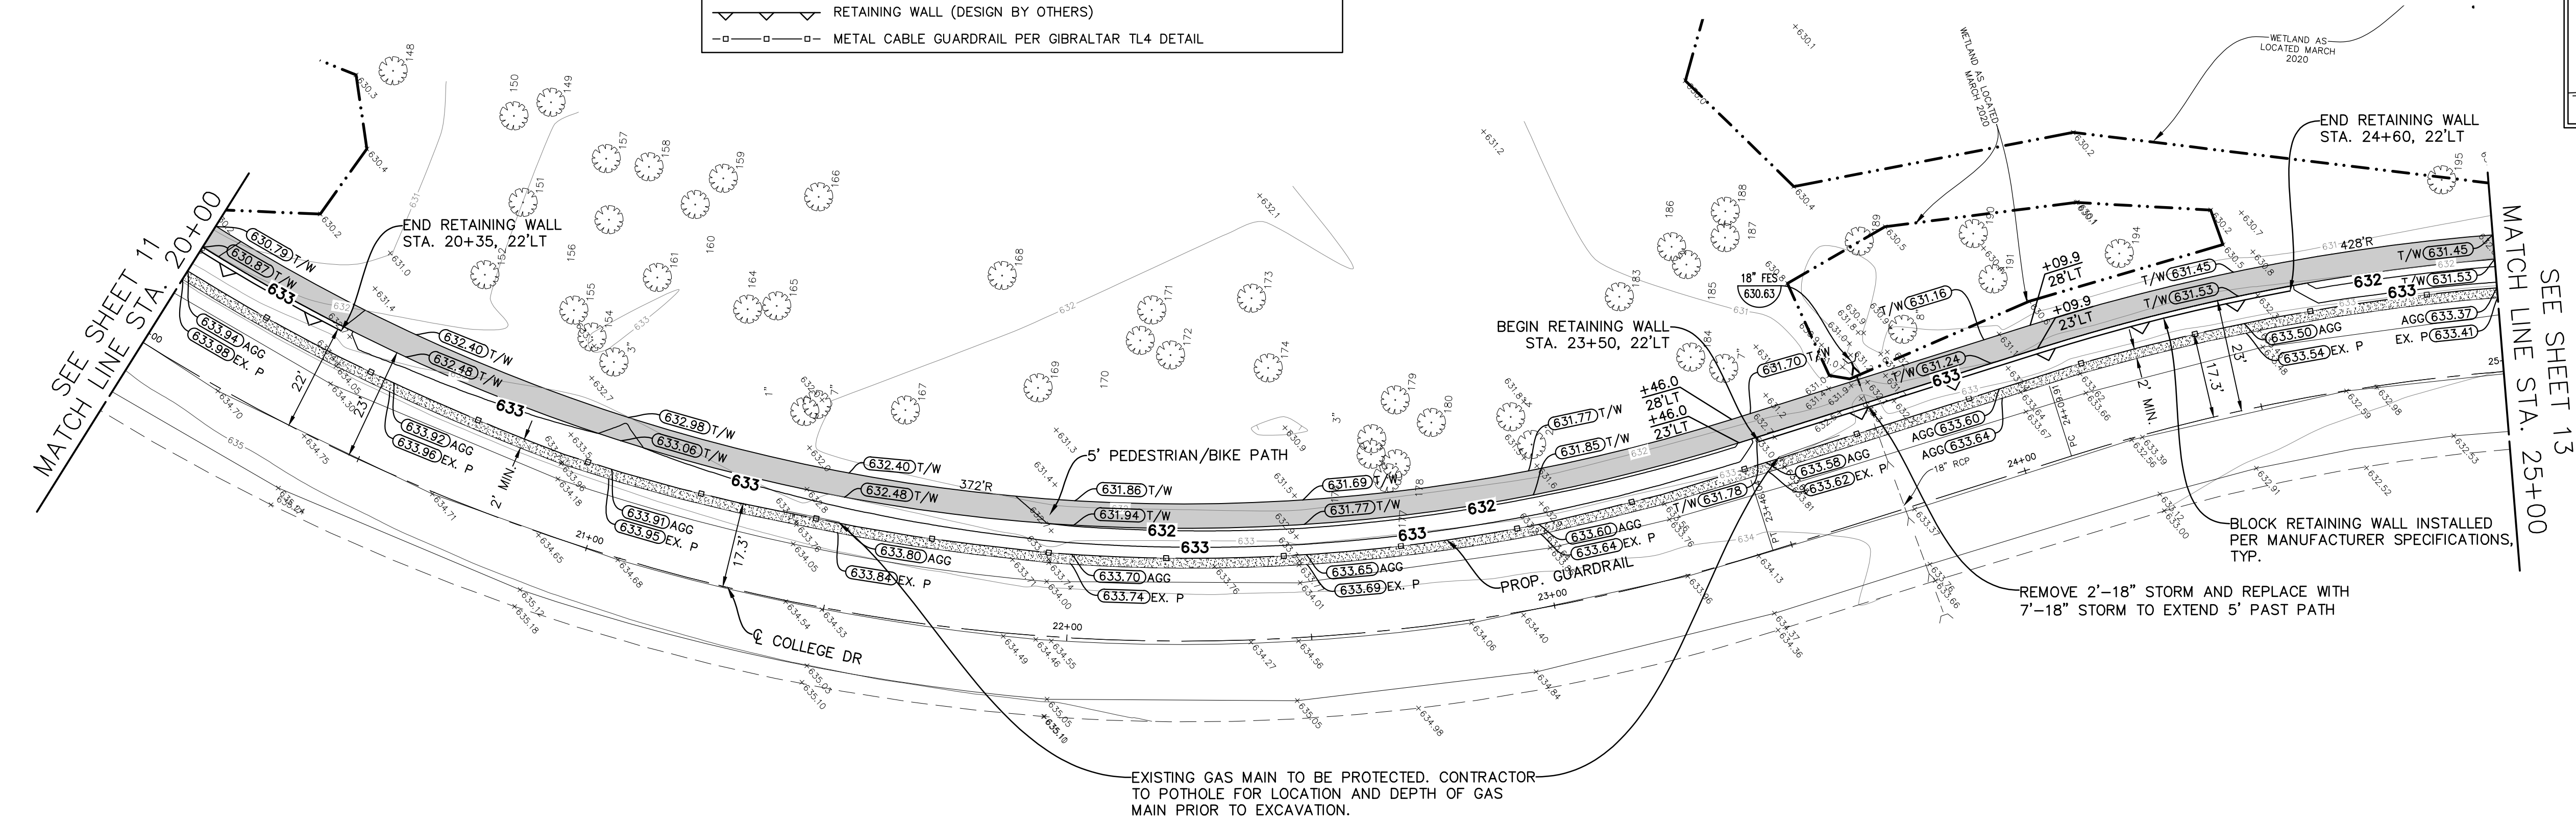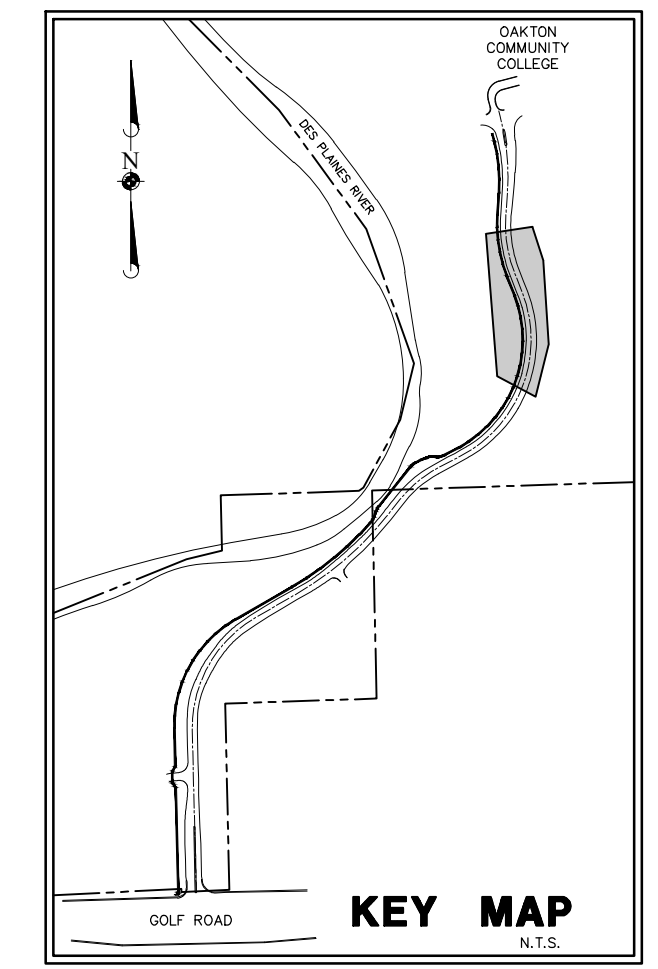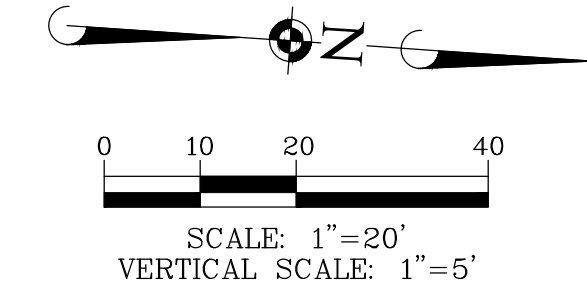

PEDESTRIAN AND BICYCLE PATHWAY ALONG COLLEGE DRIVE

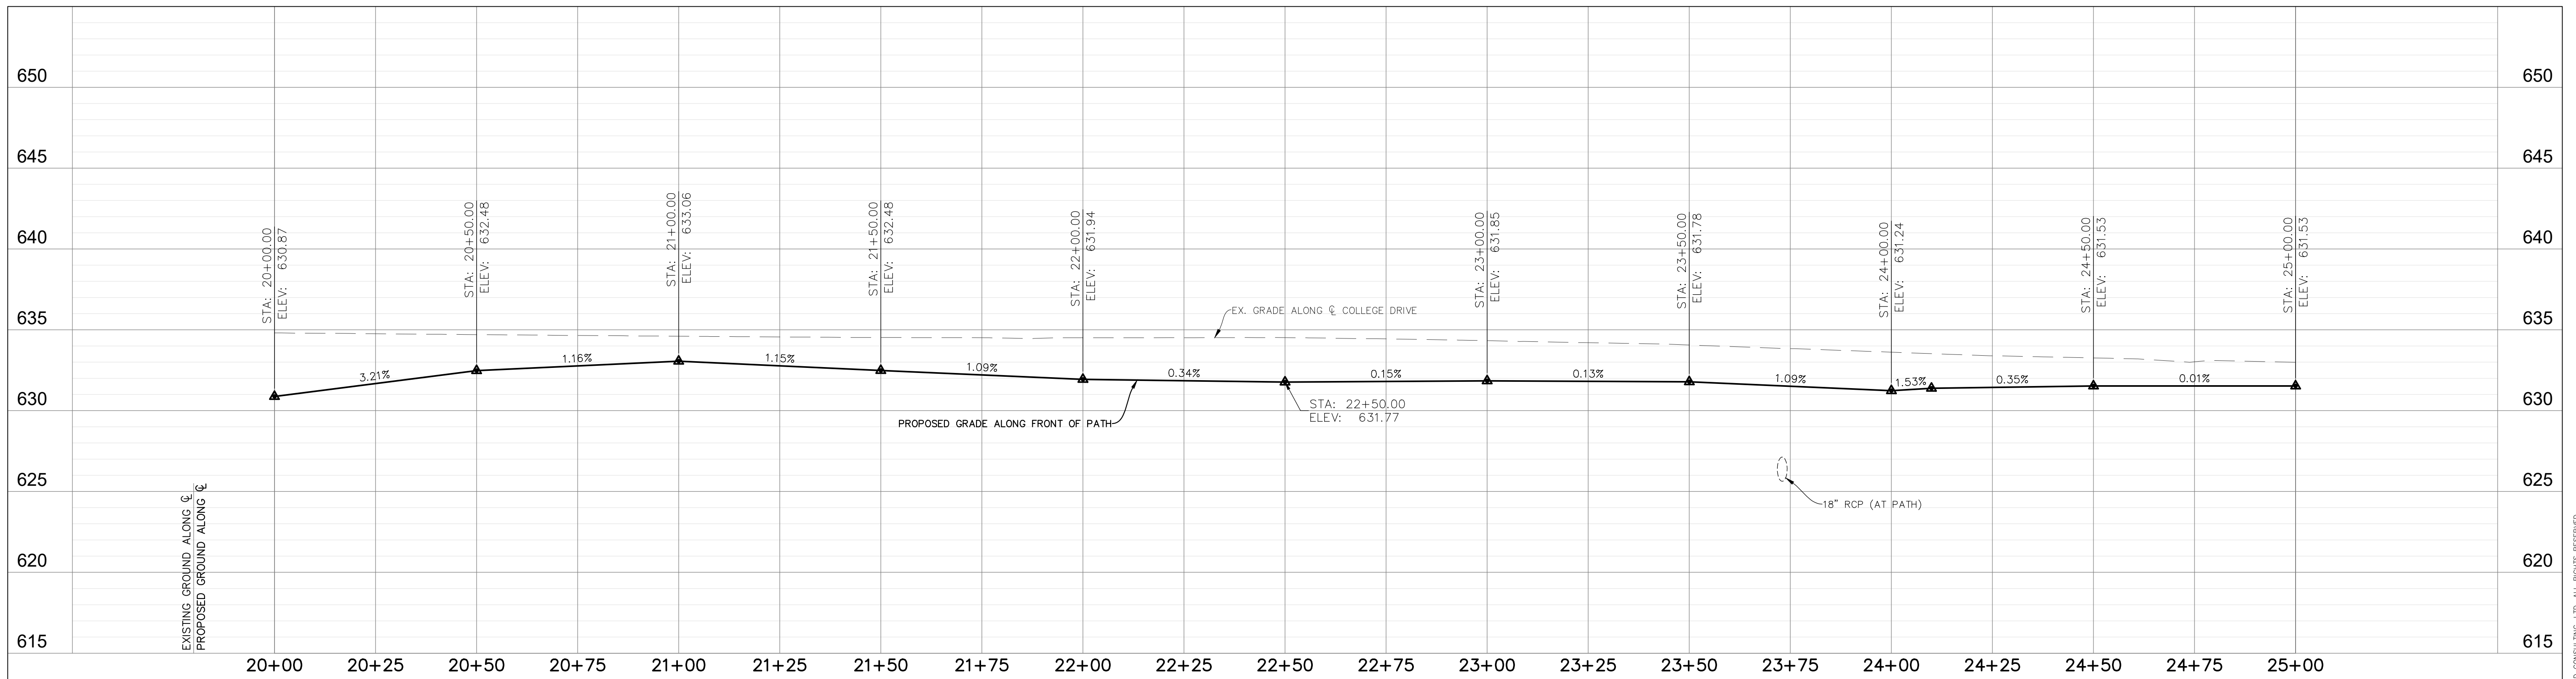

December 21, 2022 - 10:19 Draw Name: g:\occdp\10\Oak\Final\Drawings\Plan_Sht_V08-13-P&P.dwg Updated By: Whom

DATE	REVISIONS
01-19-22	REVISED FOR METAL CABLE GUARDRAIL
11-10-21	ISSUED FOR BIDS

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 Construction Managers • Environmental Scientists • Landscape Architects • Planners

PEDESTRIAN AND BICYCLE PATHWAY
OAKTON COMMUNITY COLLEGE - DES PLAINES CAMPUS
PLAN AND PROFILE - COLLEGE DRIVE STA. 20+00 TO 25+00

PROJ. MGR.: DBM
 PROJ. ASSOC.: JWS
 DRAWN BY: REH
 DATE: 05-04-21
 SCALE: H: 1"=20' V: 1"=5'
 SHEET
12 OF 30
 OCCDP110

ISSUED FOR BID

- SOIL EROSION AND SEDIMENTATION CONTROL GENERAL NOTES:**
- ALL VEGETATIVE AND STRUCTURAL EROSION CONTROL PRACTICES SHALL BE CONSTRUCTED AND MAINTAINED IN ACCORDANCE WITH THE MINIMUM STANDARDS AND SPECIFICATIONS OF THE "ILLINOIS URBAN MANUAL".
 - MAINTENANCE AND REPLACEMENT OF EROSION CONTROL ITEMS, WHEN DIRECTED BY THE OWNER, SHALL BE CONSIDERED AS INCIDENTAL TO THE CONTRACT.
 - THE CONTRACTOR SHALL INSPECT ALL EROSION CONTROL MEASURES AT LEAST ONCE EVERY SEVEN (7) CALENDAR DAYS AND WITHIN 24 HOURS OF THE END OF A STORM THAT IS 0.5 INCHES OR GREATER OR EQUIVALENT SNOWFALL. ANY NECESSARY REPAIRS OR CLEANUP TO MAINTAIN THE EFFECTIVENESS OF SAID MEASURES SHALL BE MADE IMMEDIATELY.
 - INSTALL ALL PERIMETER SILT FENCING PRIOR TO ANY CLEARING OR GRADING. ON-SITE SEDIMENT CONTROL MEASURES AS SHOWN AND SPECIFIED BY THIS EROSION AND SEDIMENTATION CONTROL PLAN SHALL BE CONSTRUCTED AND FUNCTIONAL PRIOR TO INITIATING CLEARING, GRADING, STRIPPING, EXCAVATION OR FILLING ACTIVITIES ON THE SITE.
 - THE CONTRACTOR SHALL CONSTRUCT DITCHES, SWALES, SEDIMENT TRAPS AND SILTATION CONTROL MEASURES AS REQUIRED TO INTERCEPT SURFACE WATERS BEFORE THEY FLOW ONTO ADJACENT PROPERTY.
 - STABILIZATION OF DISTURBED AREAS MUST BE INITIATED IMMEDIATELY WHENEVER ANY CLEARING, GRADING, EXCAVATING OR OTHER EARTH DISTURBING ACTIVITIES HAVE PERMANENTLY CEASED ON ANY PORTION OF THE SITE, OR TEMPORARILY CEASED ON ANY PORTION OF THE SITE AND WILL NOT RESUME FOR A PERIOD EXCEEDING 14 CALENDAR DAYS. STABILIZATION OF DISTURBED AREAS MUST BE INITIATED WITHIN 1 WORKING DAY OF PERMANENT OR TEMPORARY CESSATION OF EARTH DISTURBING ACTIVITIES AND SHALL BE COMPLETED AS SOON AS POSSIBLE BUT NOT LATER THAN 14 DAYS FROM THE INITIATION OF STABILIZATION WORK IN AN AREA.
 - TEMPORARY SEED MIXTURE SHALL BE APPLIED AT 64 LBS./ACRE.
 - INLET PROTECTION SHALL BE INSTALLED UNDER THE GRATING OF EACH DRAINAGE STRUCTURE.
 - STABILIZATION OF TOPSOIL STOCKPILES SHALL BE INITIATED IMMEDIATELY UPON COMPLETION UNLESS THEY WILL BE DISTURBED WITHIN FOURTEEN (14) CALENDAR DAYS. STABILIZATION OF STOCKPILES MUST BE INITIATED WITHIN 1 WORKING DAY OF PERMANENT OR TEMPORARY CESSATION OF EARTH DISTURBING ACTIVITIES AND SHALL BE COMPLETED AS SOON AS POSSIBLE BUT NOT LATER THAN 14 DAYS FROM THE INITIATION OF STABILIZATION WORK IN AN AREA. ALL SOIL STORAGE PILES SHALL BE PROTECTED FROM EROSION WITH SILT FENCE ON THE DOWN SLOPE SIDE OF THE PILES.

- DURING DEWATERING OPERATIONS, WATER WILL BE PUMPED INTO FILTER BAGS. DEWATERING DIRECTLY INTO FIELD TILES OR STORMWATER STRUCTURES IS PROHIBITED.
- WATER PUMPED DURING CONSTRUCTION OPERATION SHALL BE FILTERED.
- DUST CONTROL SHALL BE PERFORMED ON A DAILY BASIS USING WATER DISPERSED FROM A TRUCK MOUNTED TANK WITH STANDARD DISCHARGE HEADER TO PROVIDE A UNIFORM RATE OF APPLICATION.
- TEMPORARY GRAVEL CONSTRUCTION ENTRANCES SHALL BE MAINTAINED, ADJUSTED OR RELOCATED AS NECESSARY TO PREVENT SEDIMENT FROM BEING TRACKED ONTO PUBLIC ROADWAYS. ANY SEDIMENT REACHING A PUBLIC ROAD SHALL BE REMOVED BY SHOVELING OR STREET CLEANING BEFORE THE END OF EACH WORKING DAY.
- ANY LOOSE MATERIAL THAT IS DEPOSITED IN THE FLOW LINE OF ANY GUTTER OR DRAINAGE STRUCTURE DURING CONSTRUCTION OPERATIONS SHALL BE REMOVED AT THE CLOSE OF EACH WORKING DAY.
- THE EROSION CONTROL MEASURES INDICATED ON THE PLANS ARE THE MINIMUM REQUIREMENTS. ADDITIONAL MEASURES MAY BE REQUIRED, AS DIRECTED BY THE CLIENT OR OTHER JURISDICTIONAL GOVERNMENTAL ENTITIES.
- ALL EROSION AND SEDIMENTATION CONTROL MEASURES SHALL BE REMOVED AND DISPOSED OF IN ACCORDANCE WITH ALL JURISDICTIONAL GOVERNMENTAL AGENCY REQUIREMENTS WITHIN 30 DAYS OF FINAL STABILIZATION.
- CONTRACTOR TO SCHEDULE A PRE-CONSTRUCTION MEETING NORTH COOK COUNTY SOIL AND WATER CONSERVATION DISTRICT (SWCD) TO DISCUSS THE SESC PLAN AND THE INSTALLATION AND MAINTENANCE REQUIREMENTS OF THE SESC PRACTICES ON THE SITE. CONTRACTOR TO CONTACT THE SWCD AT LEAST 10 CALENDAR DAYS PRIOR TO THE PRE-CONSTRUCTION MEETING SO THAT A REPRESENTATIVE MAY ATTEND. THEY CAN BE REACHED AT (224) 875-7580.
- CONTRACTOR SHALL NOTIFY THE SWCD OF ANY CHANGES OR MODIFICATIONS TO THE APPROVED PLAN SET. FIELD CONDITIONS DURING PROJECT CONSTRUCTION MAY REQUIRE THE IMPLEMENTATION OF ADDITIONAL SESC MEASURES. IF YOU FAIL TO IMPLEMENT CORRECTIVE MEASURES, THIS OFFICE MAY REQUIRE MORE FREQUENT SITE INSPECTIONS TO ENSURE THE INSTALLED SESC MEASURES ARE ACCEPTABLE.

- CONSTRUCTION SEQUENCE:**
- INSTALL SILT FENCE AND CULVERT PROTECTION AT LOCATIONS AS INDICATED ON THE PLANS.
 - PROVIDE STABILIZED CONSTRUCTION ENTRANCE.
 - CONSTRUCT TEMPORARY SEDIMENT TRAPS AS NECESSARY.
 - STRIP EXISTING TOPSOIL FROM PROPOSED LIMITS OF DISTURBANCE AND STOCKPILE WHERE SHOWN ON PLANS.
 - PROVIDE SILT FENCE AROUND THE BASE OF THE STOCKPILES.
 - CUT AND FILL SITE TO PLAN SUB-GRADE.
 - CONSTRUCT UNDERGROUND IMPROVEMENTS, I.E. STORM SEWER**.
 - CONSTRUCT PAVEMENT IMPROVEMENTS PER PLAN.
 - COMPLETE CONSTRUCTION OF SITE WITH PERMANENT STABILIZATION.
 - REMOVE TEMPORARY EROSION AND SEDIMENT CONTROL MEASURES.
 - INSTALL INLET PROTECTION AROUND DRAINAGE STRUCTURES AS CONSTRUCTED.




SOIL PROTECTION CHART

STABILIZATION CHART	JAN	FEB	MAR	APR	MAY	JUN	JUL	AUG	SEP	OCT	NOV	DEC
PERMANENT SEEDINGS			A									
DORMANT SEEDINGS	B											
TEMPORARY SEEDINGS			C									
SOODING				E**								
MULCHING					F**							

A - KENTUCKY BLUEGRASS 90 LBS./AC. MIXED WITH PERENNIAL RYEGRASS
 B - KENTUCKY BLUEGRASS 30 LBS./AC.
 C - SPRING OATS
 D - WHEAT OR CEREAL RYE
 E - SOD (NURSERY GROWN KENTUCKY BLUEGRASS)
 F - STRAW MULCH 2 TONS PER ACRE

* IRRIGATION NEEDED DURING JUNE, JULY AND SEPTEMBER
 ** IRRIGATION NEEDED FOR 2-3 WEEKS AFTER SOODING.

NOTE: THIS CHART IS A GUIDE TO ASSIST THE CONTRACTOR IN UNDERSTANDING OPTIONS FOR SOIL STABILIZATION. THE LANDSCAPE PLAN SHALL TAKE PRECEDENCE OVER THIS CHART. ANY CONFLICT SHALL BE DISCUSSED WITH THE LANDSCAPE ARCHITECT PRIOR TO THE START OF CONSTRUCTION.

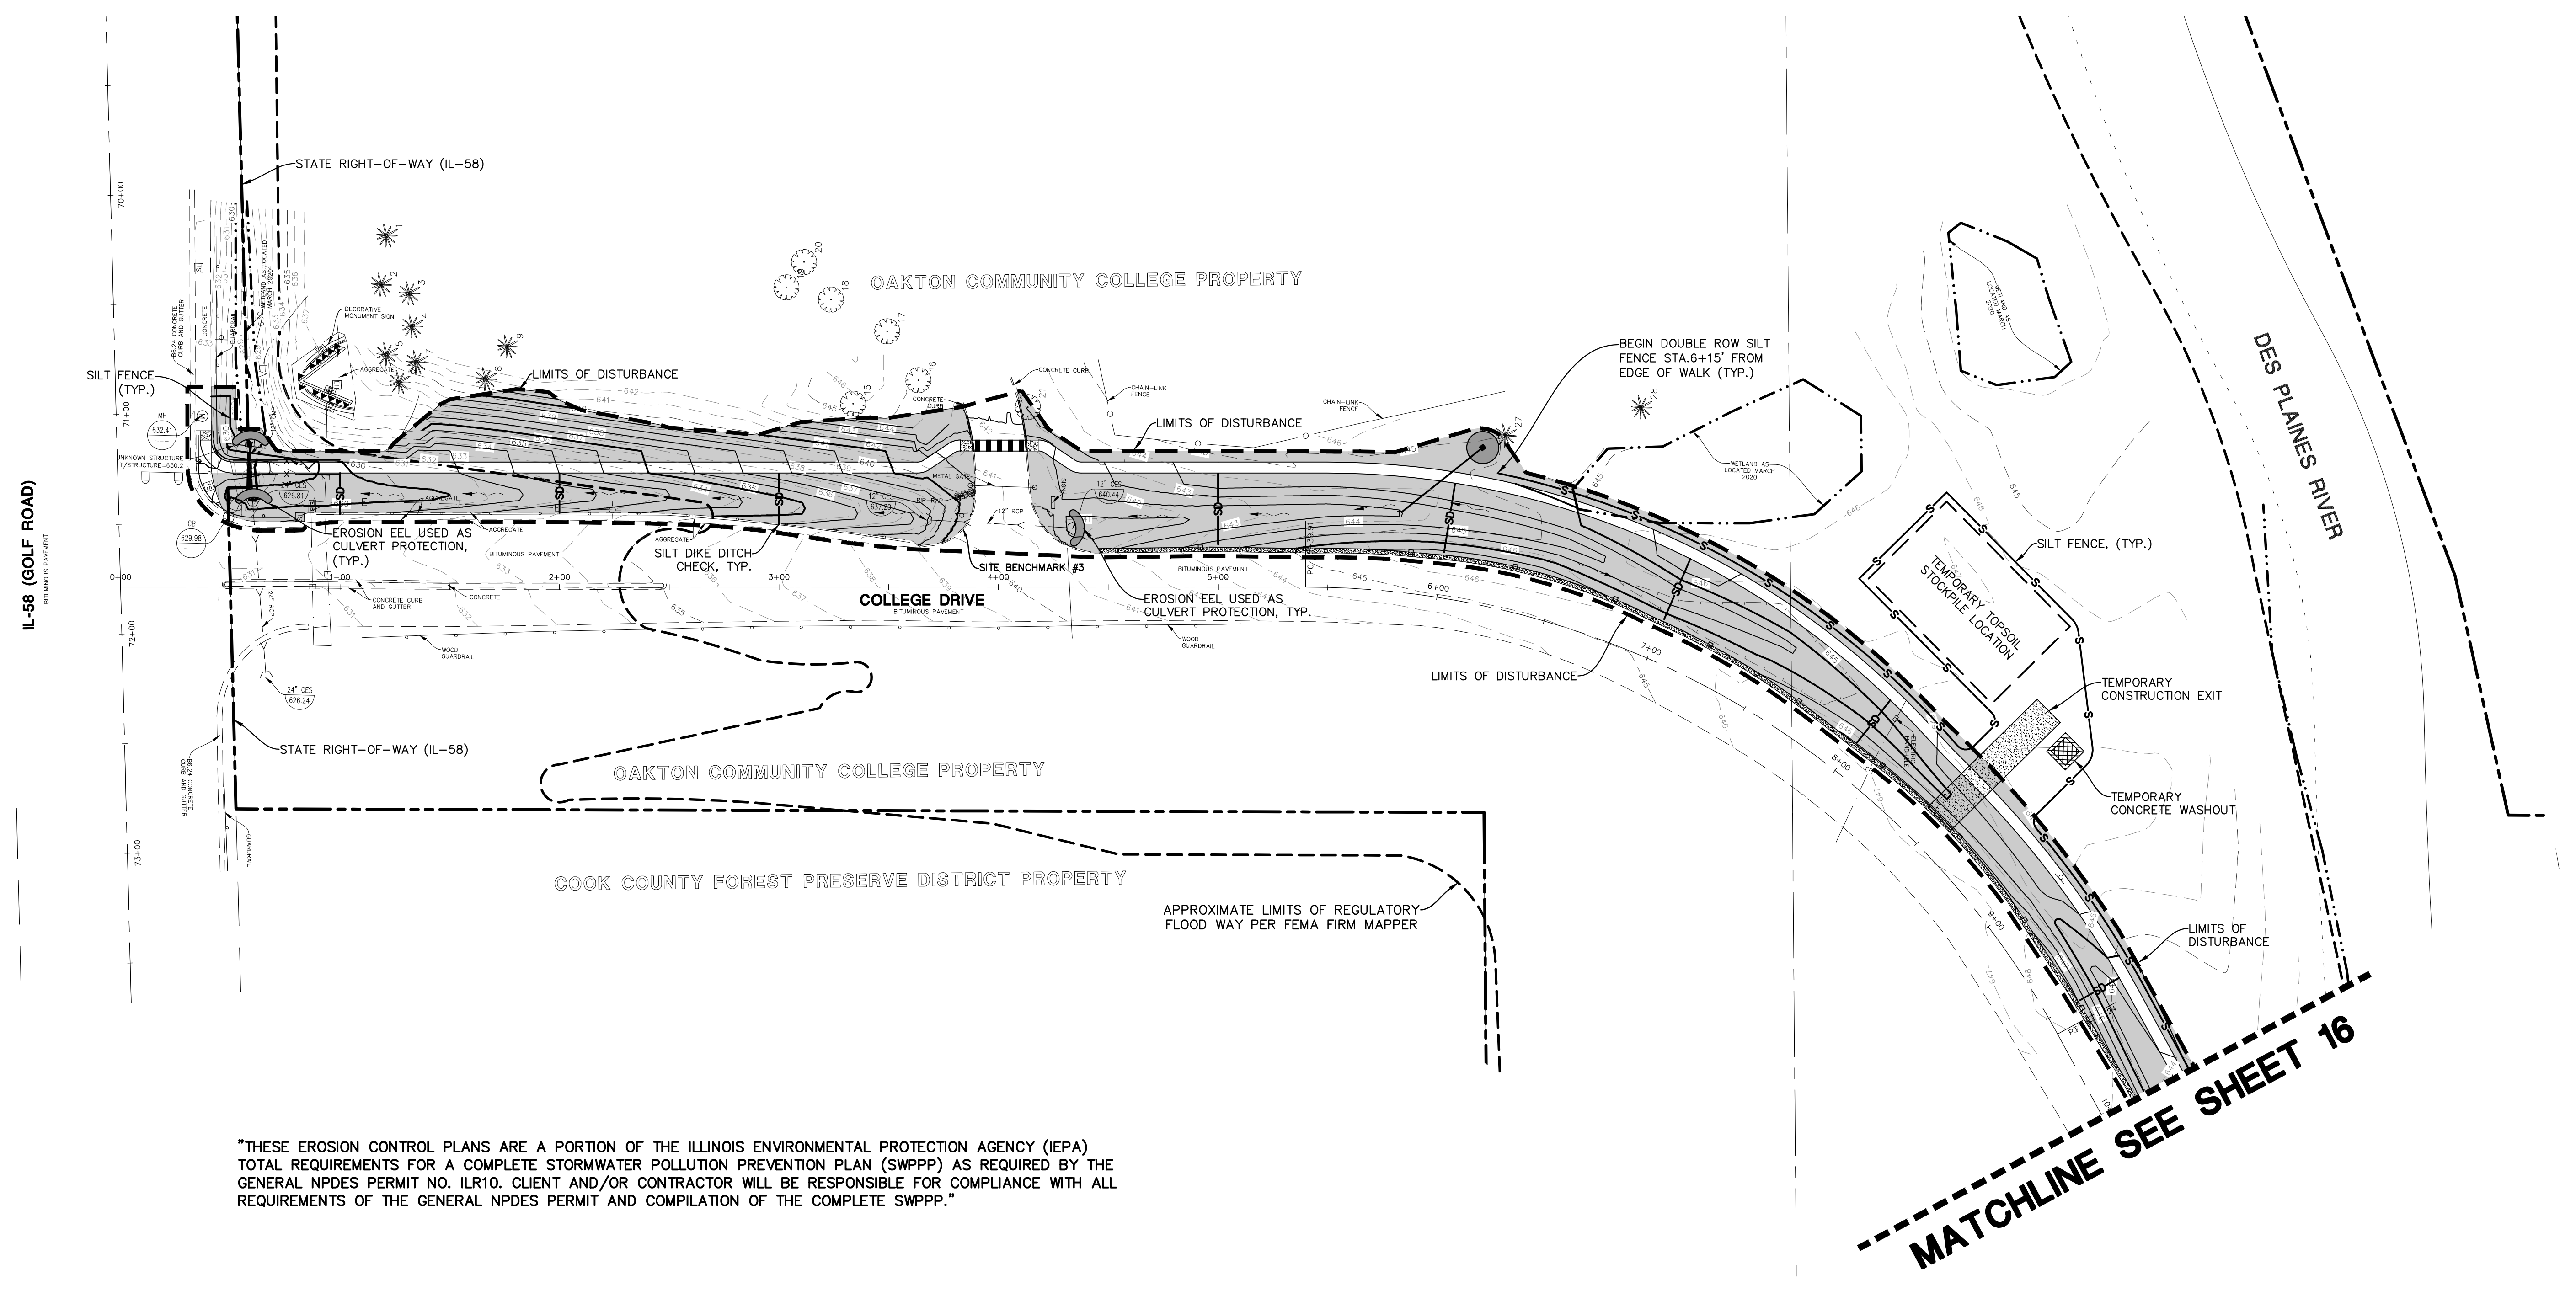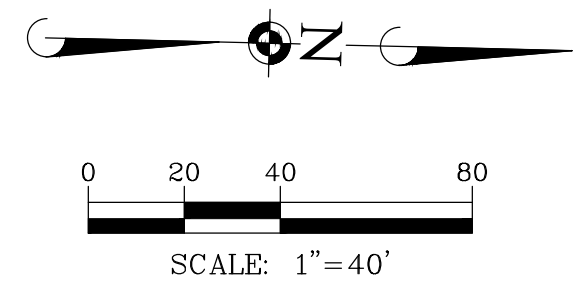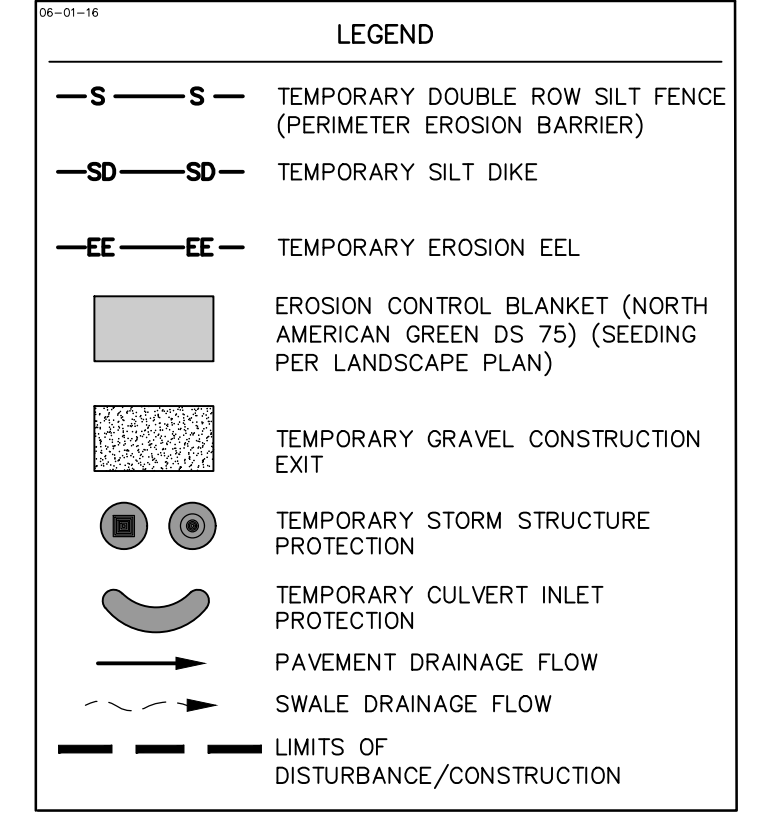

"THESE EROSION CONTROL PLANS ARE A PORTION OF THE ILLINOIS ENVIRONMENTAL PROTECTION AGENCY (IEPA) TOTAL REQUIREMENTS FOR A COMPLETE STORMWATER POLLUTION PREVENTION PLAN (SWPPP) AS REQUIRED BY THE GENERAL NPDES PERMIT NO. ILR10. CLIENT AND/OR CONTRACTOR WILL BE RESPONSIBLE FOR COMPLIANCE WITH ALL REQUIREMENTS OF THE GENERAL NPDES PERMIT AND COMPILATION OF THE COMPLETE SWPPP."

DATE	REVISIONS	BY	FOR
12-23-22	REVISED FOR BIDS	NBA	NBA
02-09-22	FINAL BID SET	NBA	NBA
11-10-21	ISSUED FOR BIDS	NBA	NBA

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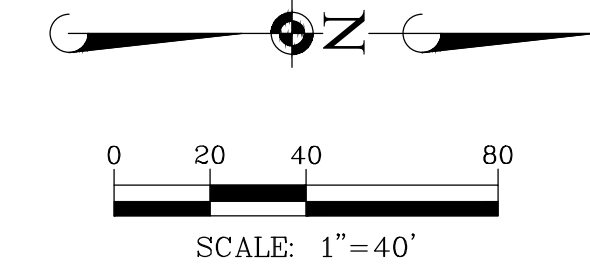
PEDESTRIAN AND BICYCLE PATHWAY
 OAKTON COMMUNITY COLLEGE - DES PLAINES CAMPUS
 SOIL EROSION AND SEDIMENT CONTROL PLAN - SOUTH

PROJ. MGR.: DBM
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 DRAWN BY: REH
 DATE: 05-04-21
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SHEET
15 OF 30
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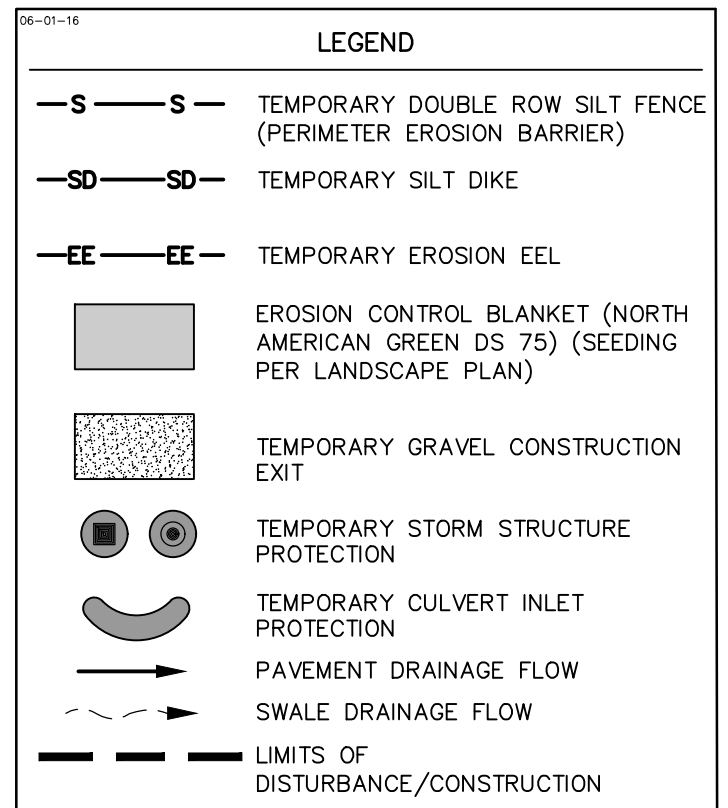
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- SOIL EROSION AND SEDIMENTATION CONTROL GENERAL NOTES:**
- ALL VEGETATIVE AND STRUCTURAL EROSION CONTROL PRACTICES SHALL BE CONSTRUCTED AND MAINTAINED IN ACCORDANCE WITH THE MINIMUM STANDARDS AND SPECIFICATIONS OF THE "ILLINOIS URBAN MANUAL".
 - MAINTENANCE AND REPLACEMENT OF EROSION CONTROL ITEMS, WHEN DIRECTED BY THE OWNER, SHALL BE CONSIDERED AS INCIDENTAL TO THE CONTRACT.
 - THE CONTRACTOR SHALL INSPECT ALL EROSION CONTROL MEASURES AT LEAST ONCE EVERY SEVEN (7) CALENDAR DAYS AND WITHIN 24 HOURS OF THE END OF A STORM THAT IS 0.5 INCHES OR GREATER OR EQUIVALENT SNOWFALL. ANY NECESSARY REPAIRS OR CLEANUP TO MAINTAIN THE EFFECTIVENESS OF SAID MEASURES SHALL BE MADE IMMEDIATELY.
 - INSTALL ALL PERIMETER SILT FENCING PRIOR TO ANY CLEARING OR GRADING. ON-SITE SEDIMENT CONTROL MEASURES AS SHOWN AND SPECIFIED BY THIS EROSION AND SEDIMENTATION CONTROL PLAN SHALL BE CONSTRUCTED AND FUNCTIONAL PRIOR TO INITIATING CLEARING, GRADING, STRIPPING, EXCAVATION OR FILLING ACTIVITIES ON THE SITE.
 - THE CONTRACTOR SHALL CONSTRUCT DITCHES, SWALES, SEDIMENT TRAPS AND SILTATION CONTROL MEASURES AS REQUIRED TO INTERCEPT SURFACE WATERS BEFORE THEY FLOW ONTO ADJACENT PROPERTY.
 - STABILIZATION OF DISTURBED AREAS MUST BE INITIATED IMMEDIATELY WHENEVER ANY CLEARING, GRADING, EXCAVATING OR OTHER EARTH DISTURBING ACTIVITIES HAVE PERMANENTLY CEASED ON ANY PORTION OF THE SITE, OR TEMPORARILY CEASED ON ANY PORTION OF THE SITE AND WILL NOT RESUME FOR A PERIOD EXCEEDING 14 CALENDAR DAYS. STABILIZATION OF DISTURBED AREAS MUST BE INITIATED WITHIN 1 WORKING DAY OF PERMANENT OR TEMPORARY CESSATION OF EARTH DISTURBING ACTIVITIES AND SHALL BE COMPLETED AS SOON AS POSSIBLE BUT NOT LATER THAN 14 DAYS FROM THE INITIATION OF STABILIZATION WORK IN AN AREA.
 - TEMPORARY SEED MIXTURE SHALL BE APPLIED AT 64 LBS./ACRE.
 - INLET PROTECTION SHALL BE INSTALLED UNDER THE GRATING OF EACH DRAINAGE STRUCTURE.
 - STABILIZATION OF TOPSOIL STOCKPILES SHALL BE INITIATED IMMEDIATELY UPON COMPLETION UNLESS THEY WILL BE DISTURBED WITHIN FOURTEEN (14) CALENDAR DAYS. STABILIZATION OF STOCKPILES MUST BE INITIATED WITHIN 1 WORKING DAY OF PERMANENT OR TEMPORARY CESSATION OF EARTH DISTURBING ACTIVITIES AND SHALL BE COMPLETED AS SOON AS POSSIBLE BUT NOT LATER THAN 14 DAYS FROM THE INITIATION OF STABILIZATION WORK IN AN AREA. ALL SOIL STORAGE PILES SHALL BE PROTECTED FROM EROSION WITH SILT FENCE ON THE DOWN SLOPE SIDE OF THE PILES.
 - DURING DEWATERING OPERATIONS, WATER WILL BE PUMPED INTO FILTER BAGS. DEWATERING DIRECTLY INTO FIELD TILES OR STORMWATER STRUCTURES IS PROHIBITED.
 - WATER PUMPED DURING CONSTRUCTION OPERATION SHALL BE FILTERED.
 - DUST CONTROL SHALL BE PERFORMED ON A DAILY BASIS USING WATER DISPENSED FROM A TRUCK MOUNTED TANK WITH STANDARD DISCHARGE HEADER TO PROVIDE A UNIFORM RATE OF APPLICATION.
 - TEMPORARY GRAVEL CONSTRUCTION ENTRANCES SHALL BE MAINTAINED, ADJUSTED OR RELOCATED AS NECESSARY TO PREVENT SEDIMENT FROM BEING TRACKED ONTO PUBLIC ROADWAYS. ANY SEDIMENT REACHING A PUBLIC ROAD SHALL BE REMOVED BY SHOVELING OR STREET CLEANING BEFORE THE END OF EACH WORKING DAY.
 - ANY LOOSE MATERIAL THAT IS DEPOSITED IN THE FLOW LINE OF ANY GUTTER OR DRAINAGE STRUCTURE DURING CONSTRUCTION OPERATIONS SHALL BE REMOVED AT THE CLOSE OF EACH WORKING DAY.
 - THE EROSION CONTROL MEASURES INDICATED ON THE PLANS ARE THE MINIMUM REQUIREMENTS. ADDITIONAL MEASURES MAY BE REQUIRED, AS DIRECTED BY THE CLIENT OR OTHER JURISDICTIONAL GOVERNMENTAL ENTITIES.
 - ALL EROSION AND SEDIMENTATION CONTROL MEASURES SHALL BE REMOVED AND DISPOSED OF IN ACCORDANCE WITH ALL JURISDICTIONAL GOVERNMENTAL AGENCY REQUIREMENTS WITHIN 30 DAYS OF FINAL STABILIZATION.
 - CONTRACTOR TO SCHEDULE A PRE-CONSTRUCTION MEETING NORTH COOK COUNTY SOIL AND WATER CONSERVATION DISTRICT (SWCD) TO DISCUSS THE SESC PLAN AND THE INSTALLATION AND MAINTENANCE REQUIREMENTS OF THE SESC PRACTICES ON THE SITE. CONTRACTOR TO CONTACT THE SWCD AT LEAST 10 CALENDAR DAYS PRIOR TO THE PRE-CONSTRUCTION MEETING SO THAT A REPRESENTATIVE MAY ATTEND. THEY CAN BE REACHED AT (224) 875-7580.
 - CONTRACTOR SHALL NOTIFY THE SWCD OF ANY CHANGES OR MODIFICATIONS TO THE APPROVED PLAN SET. FIELD CONDITIONS DURING PROJECT CONSTRUCTION MAY REQUIRE THE IMPLEMENTATION OF ADDITIONAL SESC MEASURES. IF YOU FAIL TO IMPLEMENT CORRECTIVE MEASURES, THIS OFFICE MAY REQUIRE MORE FREQUENT SITE INSPECTIONS TO ENSURE THE INSTALLED SESC MEASURES ARE ACCEPTABLE.

- CONSTRUCTION SEQUENCE:**
- INSTALL SILT FENCE AND CULVERT PROTECTION AT LOCATIONS AS INDICATED ON THE PLANS.
 - PROVIDE STABILIZED CONSTRUCTION ENTRANCE.
 - CONSTRUCT TEMPORARY SEDIMENT TRAPS AS NECESSARY.
 - STRIP EXISTING TOPSOIL FROM PROPOSED LIMITS OF DISTURBANCE AND STOCKPILE WHERE SHOWN ON PLANS.
 - PROVIDE SILT FENCE AROUND THE BASE OF THE STOCKPILES.
 - CUT AND FILL SITE TO PLAN SUB-GRADE.
 - CONSTRUCT UNDERGROUND IMPROVEMENTS, I.E. STORM SEWER**.
 - CONSTRUCT PAVEMENT IMPROVEMENTS PER PLAN.
 - COMPLETE CONSTRUCTION OF SITE WITH PERMANENT STABILIZATION.
 - REMOVE TEMPORARY EROSION AND SEDIMENT CONTROL MEASURES.
 - ** INSTALL INLET PROTECTION AROUND DRAINAGE STRUCTURES AS CONSTRUCTED.




SOIL PROTECTION CHART

STABILIZATION CHART	JAN	FEB	MAR	APR	MAY	JUN	JUL	AUG	SEP	OCT	NOV	DEC
PERMANENT SEEDINGS				A								
DORMANT SEEDINGS				B								
TEMPORARY SEEDINGS				C								
TEMPORARY SEEDINGS				D								
SODDING				E**								
MULCHING				F								

A - KENTUCKY BLUEGRASS 90 LBS./AC. MIXED WITH PERENNIAL RYEGRASS
 B - KENTUCKY BLUEGRASS 30 LBS./AC.
 C - KENTUCKY BLUEGRASS 135 LBS./AC. MIXED WITH PERENNIAL RYEGRASS 45 LBS./AC. 2 TONS STRAW MULCH PER ACRE
 D - WHEAT OR CEREAL RYE
 E - SOI NURSERY GROWN KENTUCKY BLUEGRASS
 F - STRAW MULCH 2 TONS PER ACRE
 ** IRRIGATION NEEDED DURING JUNE, JULY AND SEPTEMBER
 ** IRRIGATION NEEDED FOR 2-3 WEEKS AFTER SODDING

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DATE	REVISIONS
11-10-21	ISSUED FOR BIDS








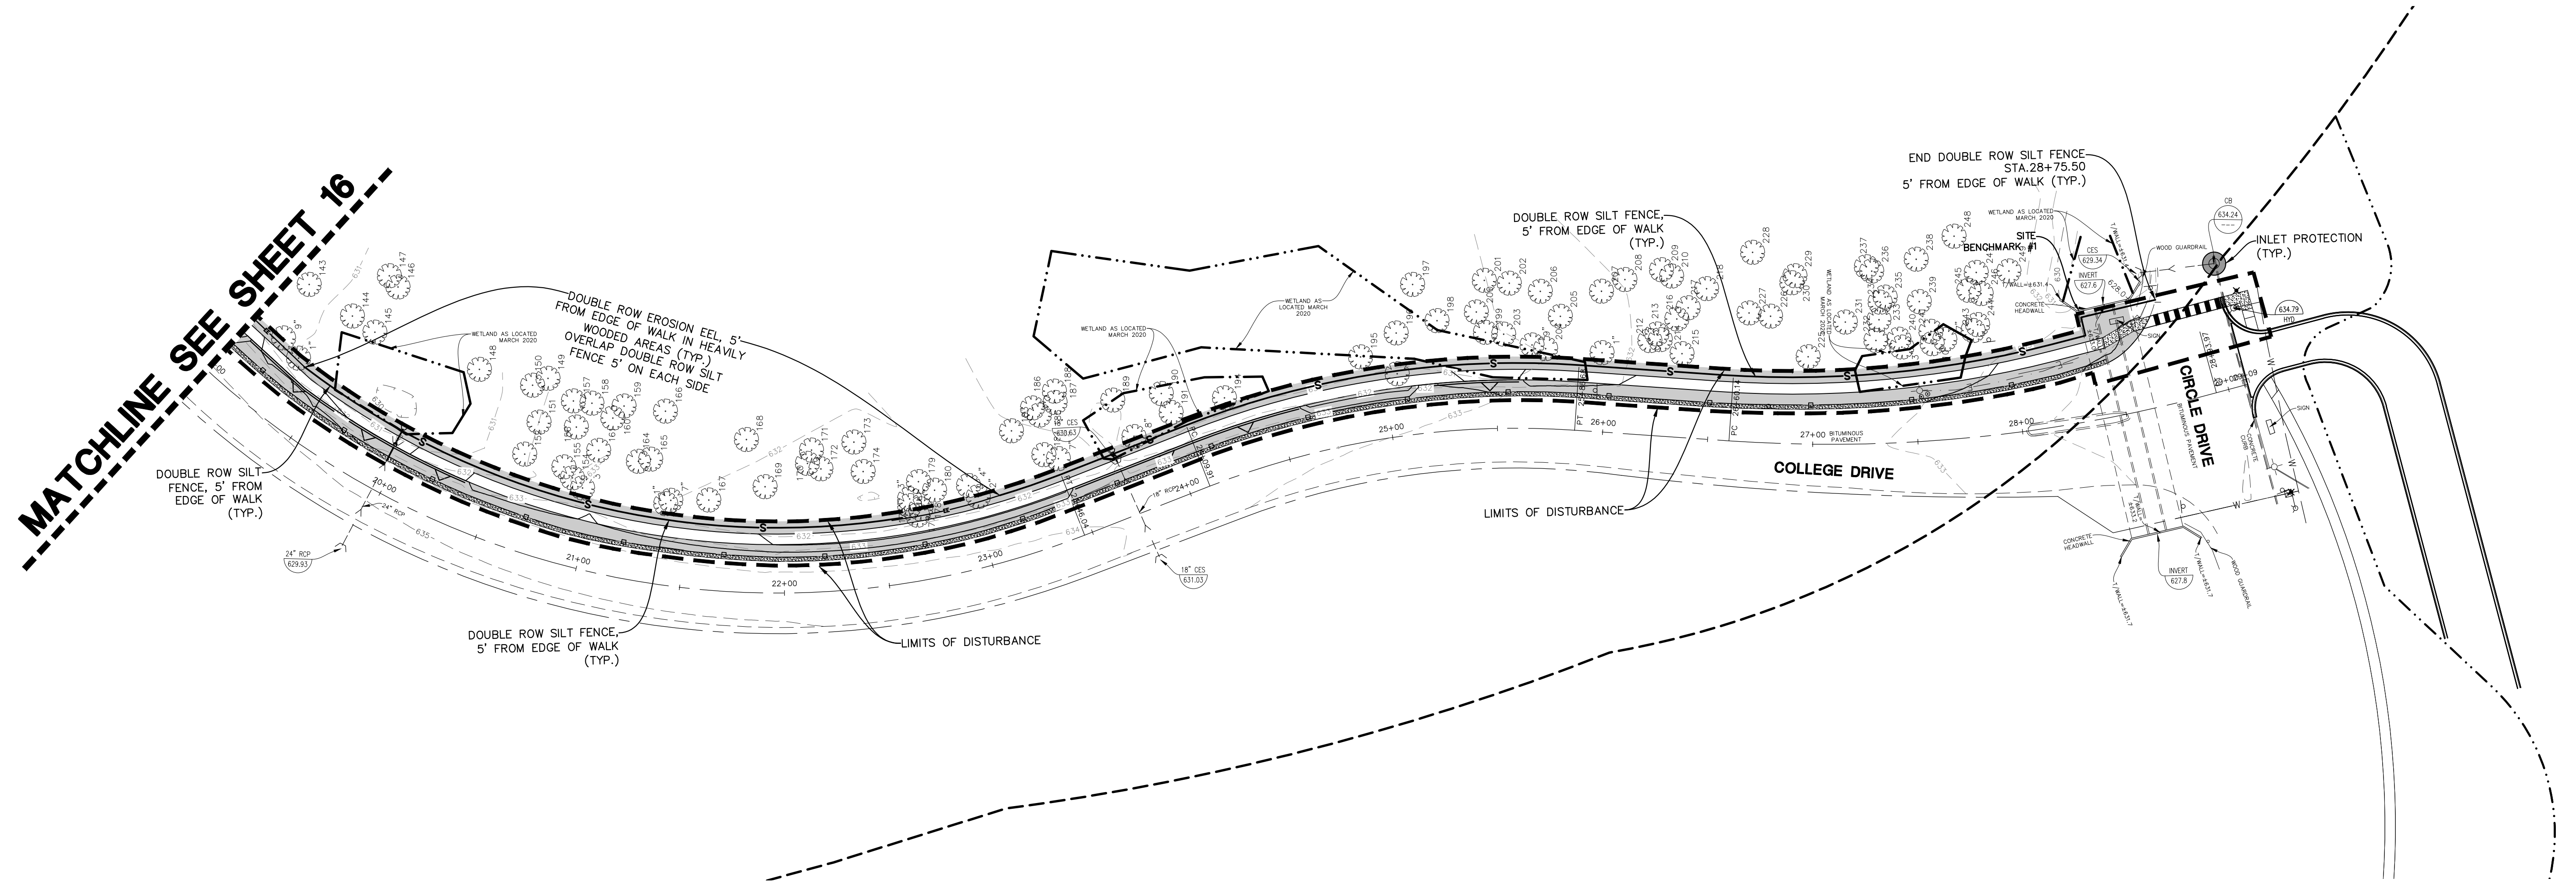
PEDESTRIAN AND BICYCLE PATHWAY
 OAKTON COMMUNITY COLLEGE - DES PLAINES CAMPUS
 SOIL EROSION AND SEDIMENT CONTROL PLAN - NORTH

PROJ. MGR.: DBM
 PROJ. ASSOC.: JWS
 DRAWN BY: REH
 DATE: 05-04-21
 SCALE: 1"=40'

SHEET
17 OF 30
 OCCDPIL10

ISSUED FOR BIDS

"THESE EROSION CONTROL PLANS ARE A PORTION OF THE ILLINOIS ENVIRONMENTAL PROTECTION AGENCY (IEPA) TOTAL REQUIREMENTS FOR A COMPLETE STORMWATER POLLUTION PREVENTION PLAN (SWPPP) AS REQUIRED BY THE GENERAL NPDES PERMIT NO. ILR10. CLIENT AND/OR CONTRACTOR WILL BE RESPONSIBLE FOR COMPLIANCE WITH ALL REQUIREMENTS OF THE GENERAL NPDES PERMIT AND COMPILATION OF THE COMPLETE SWPPP."

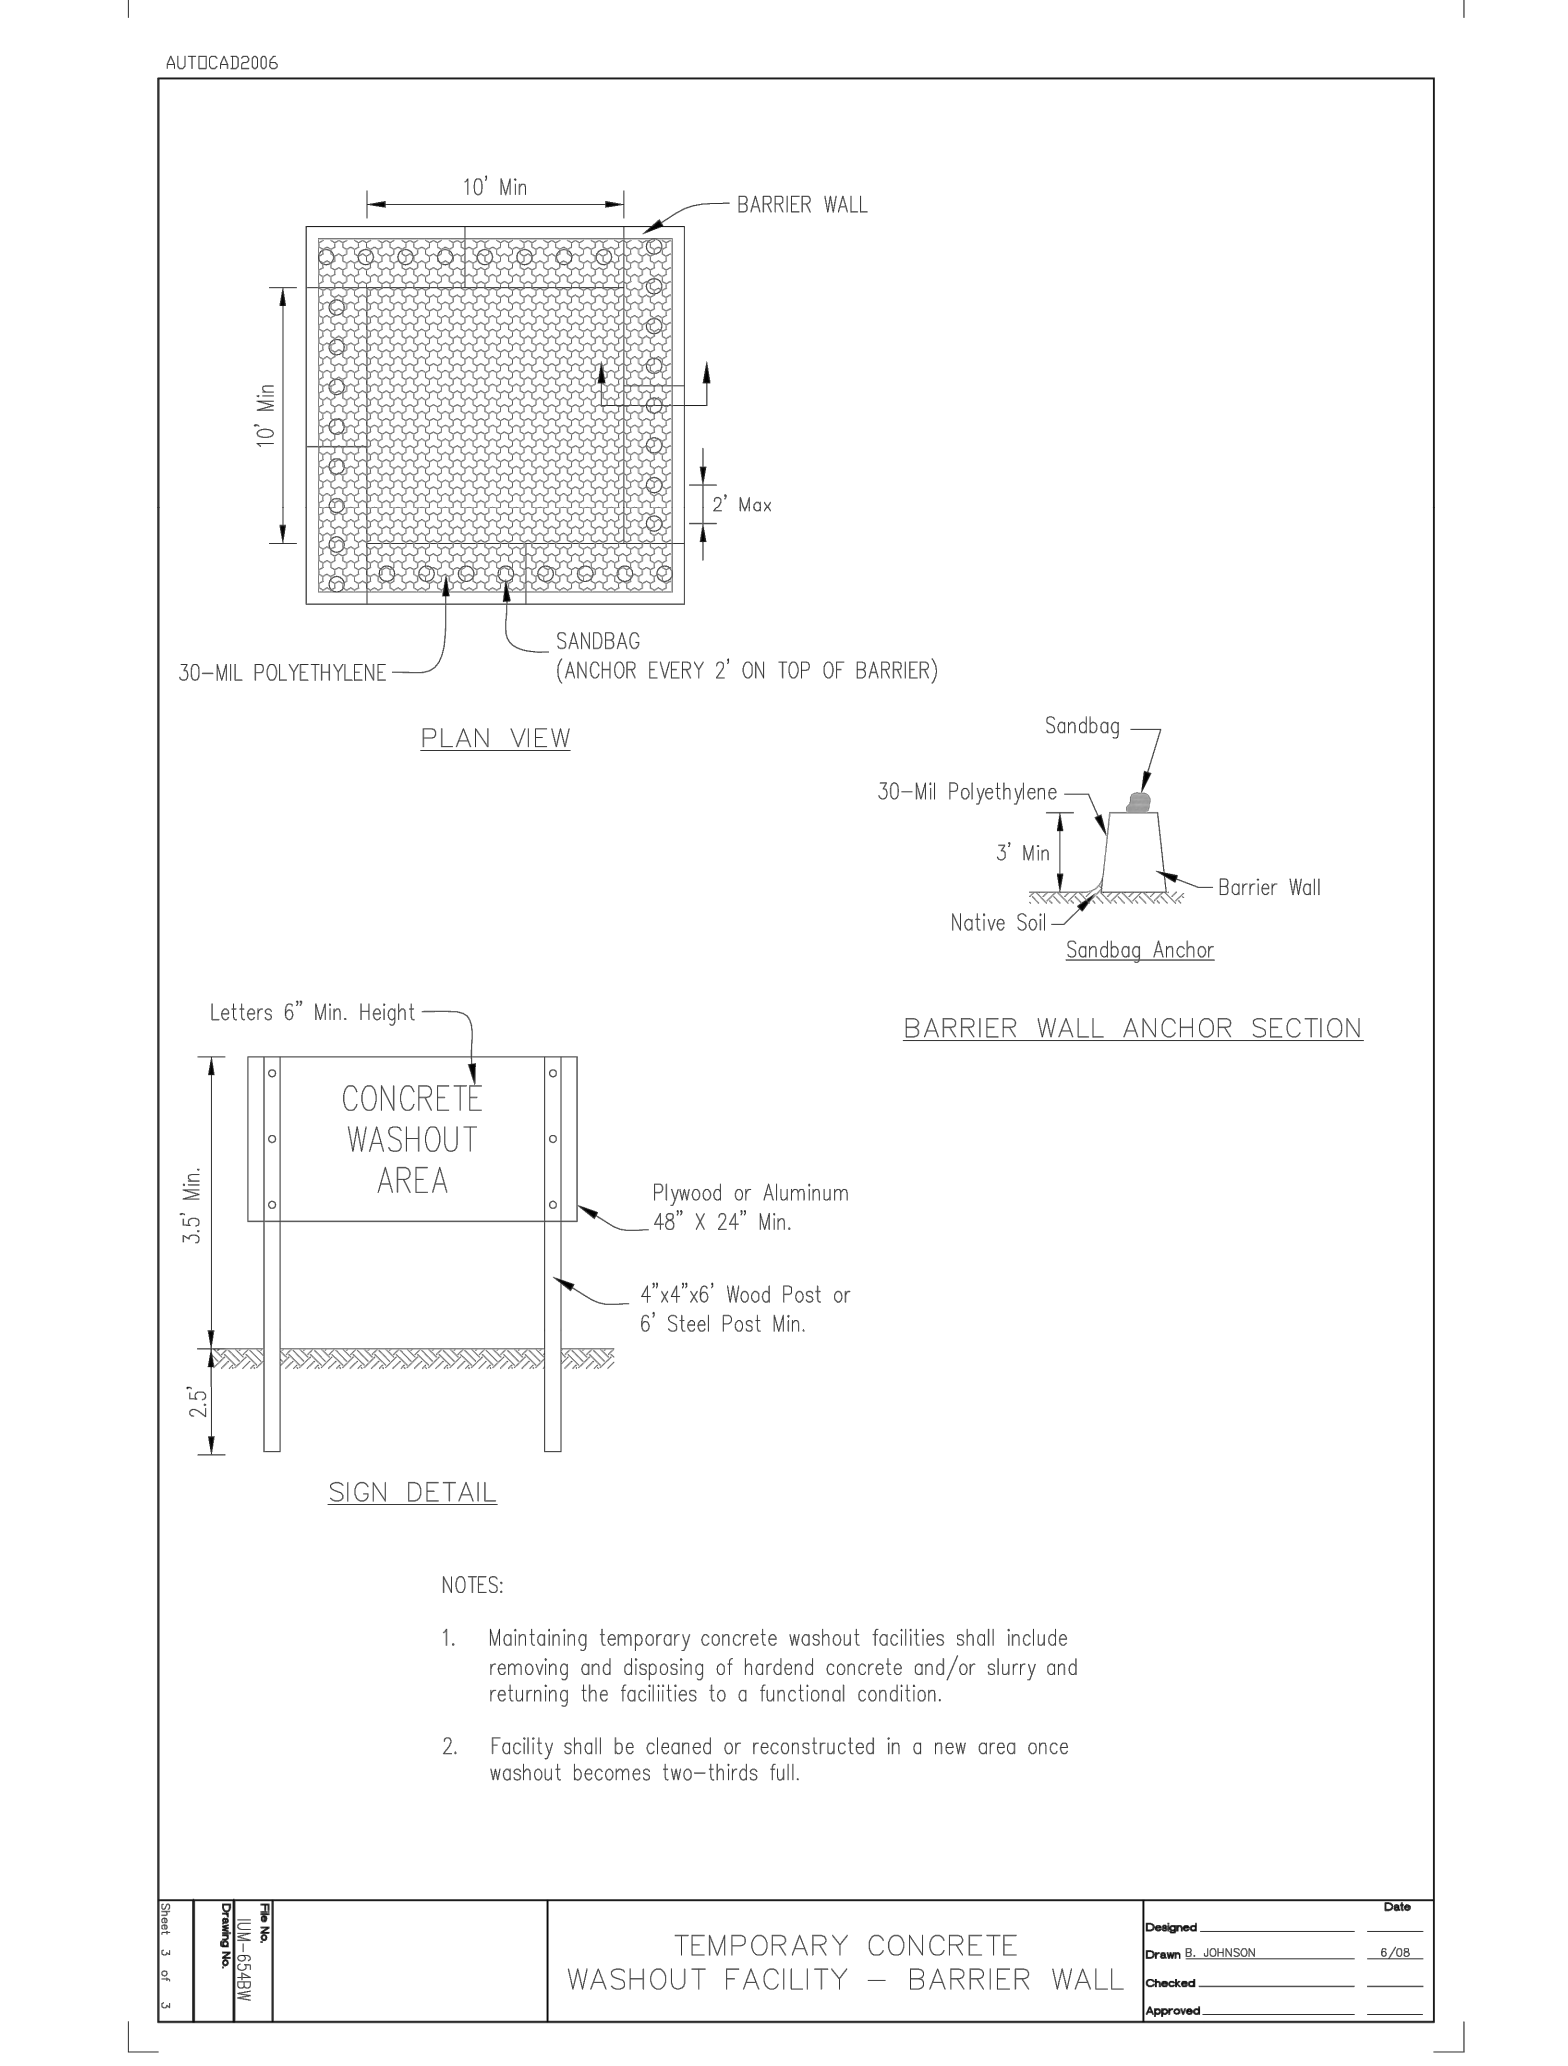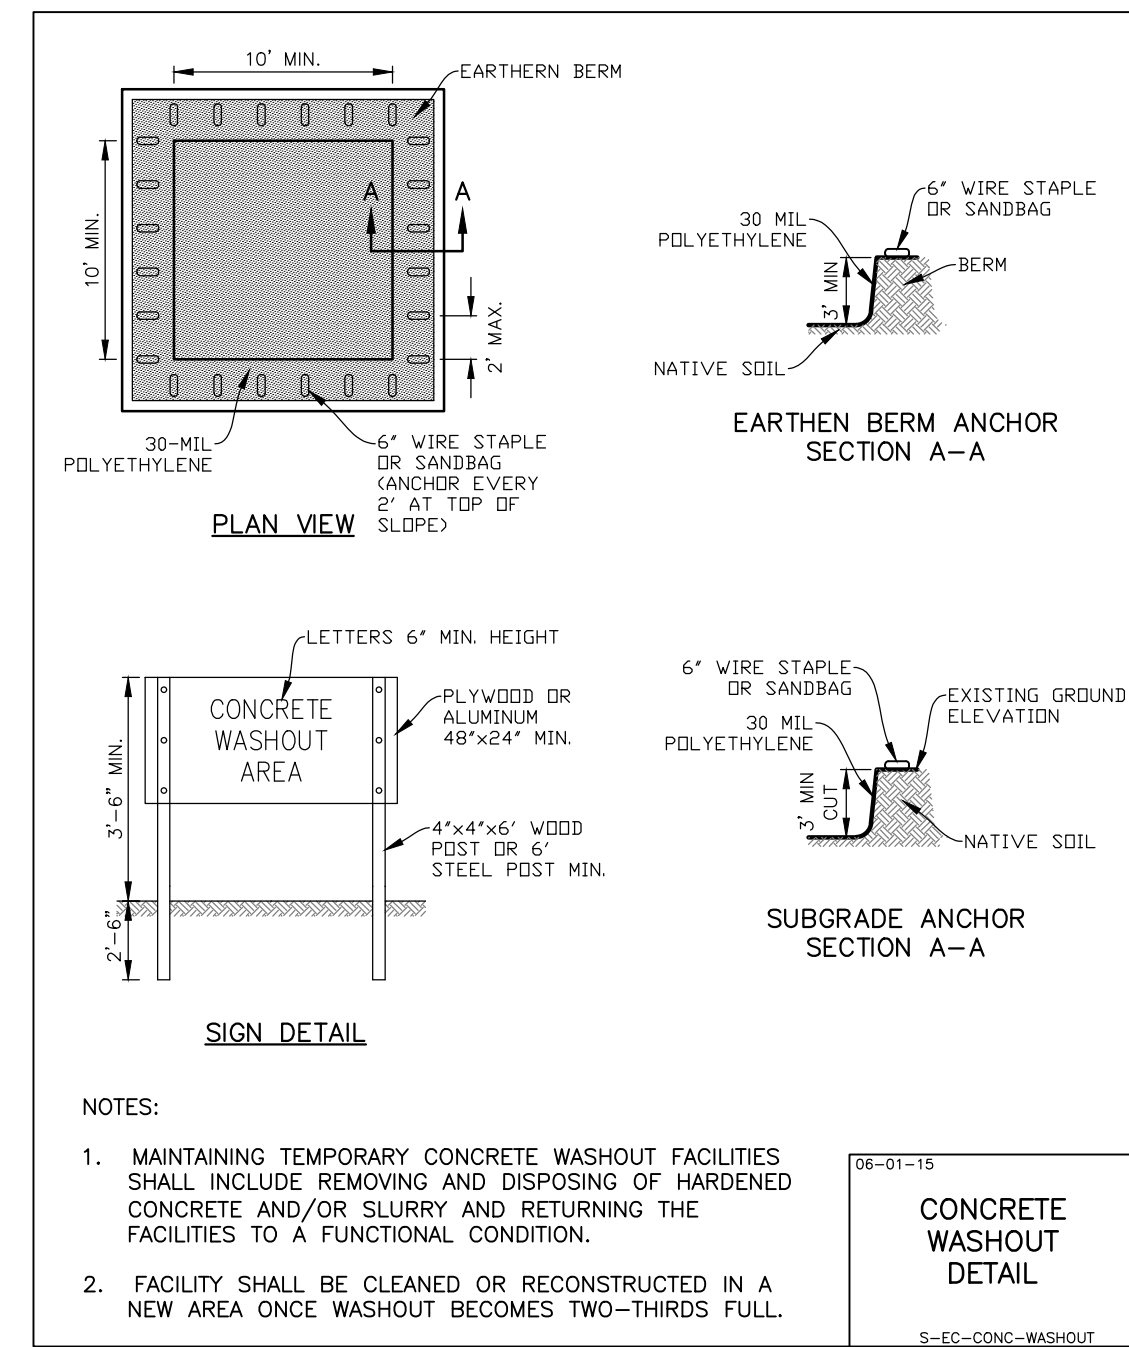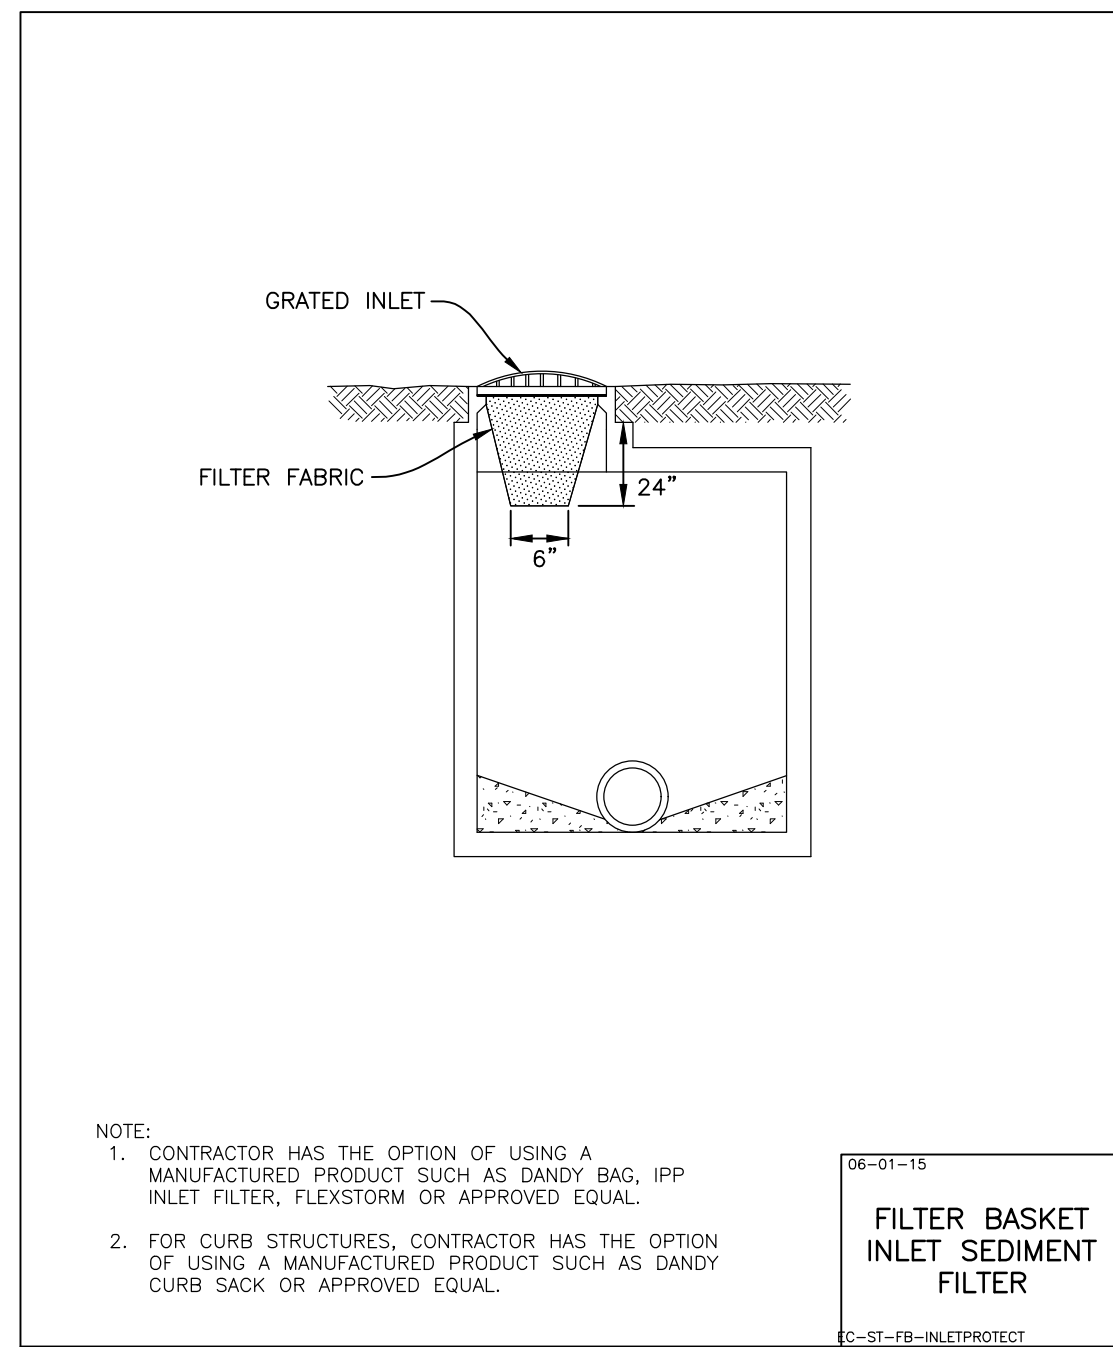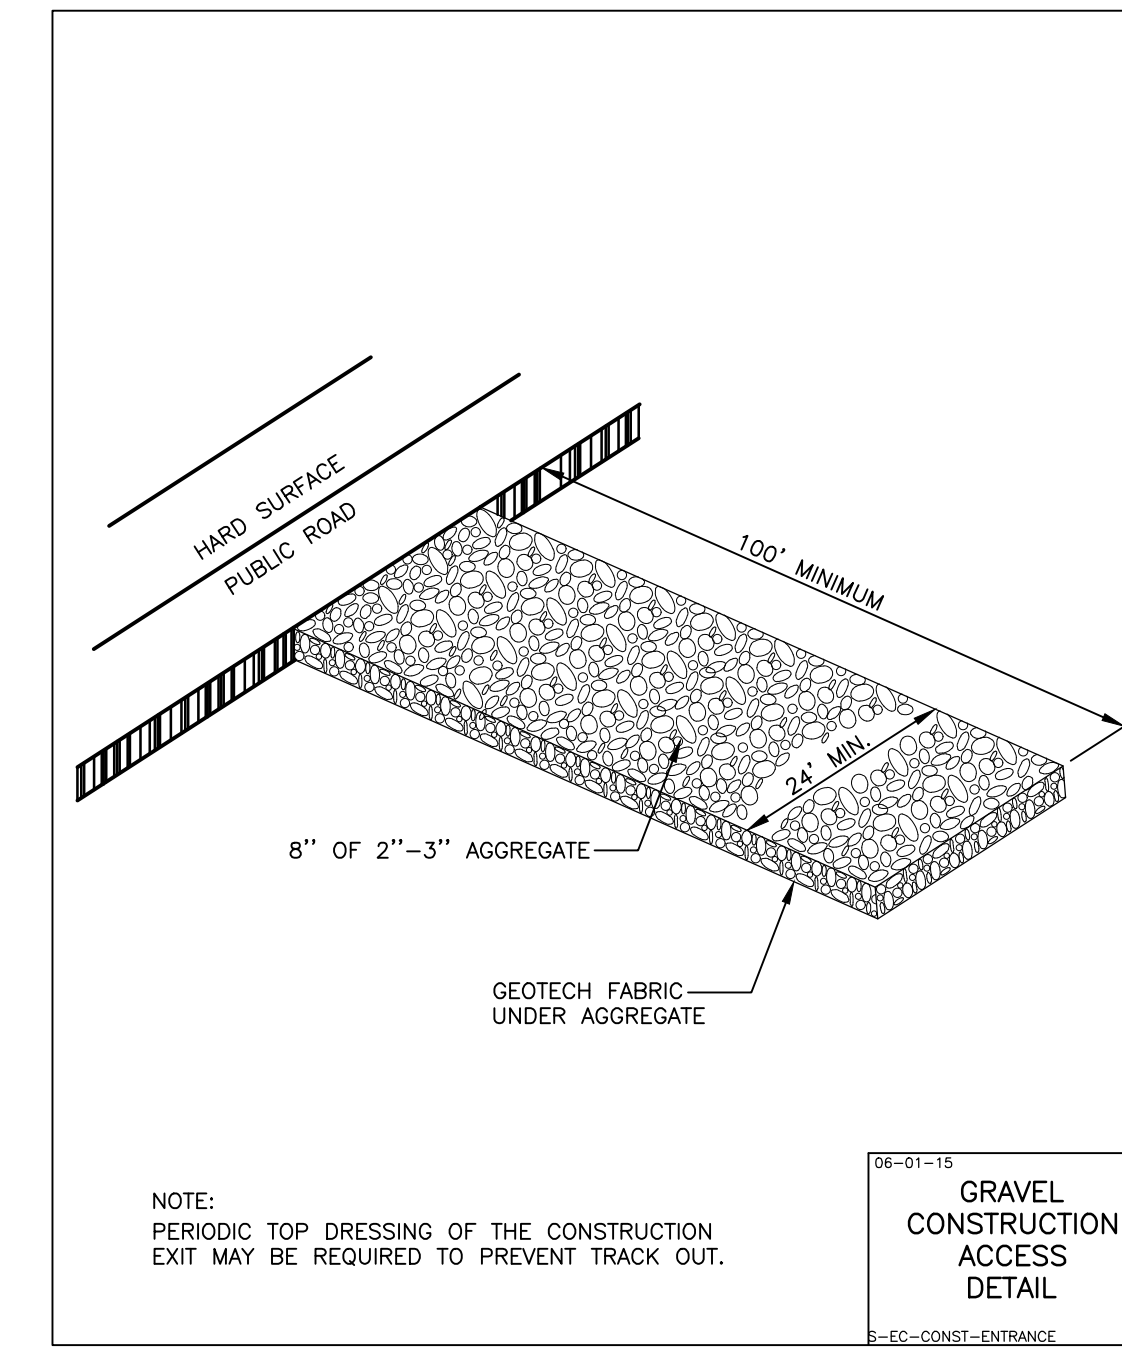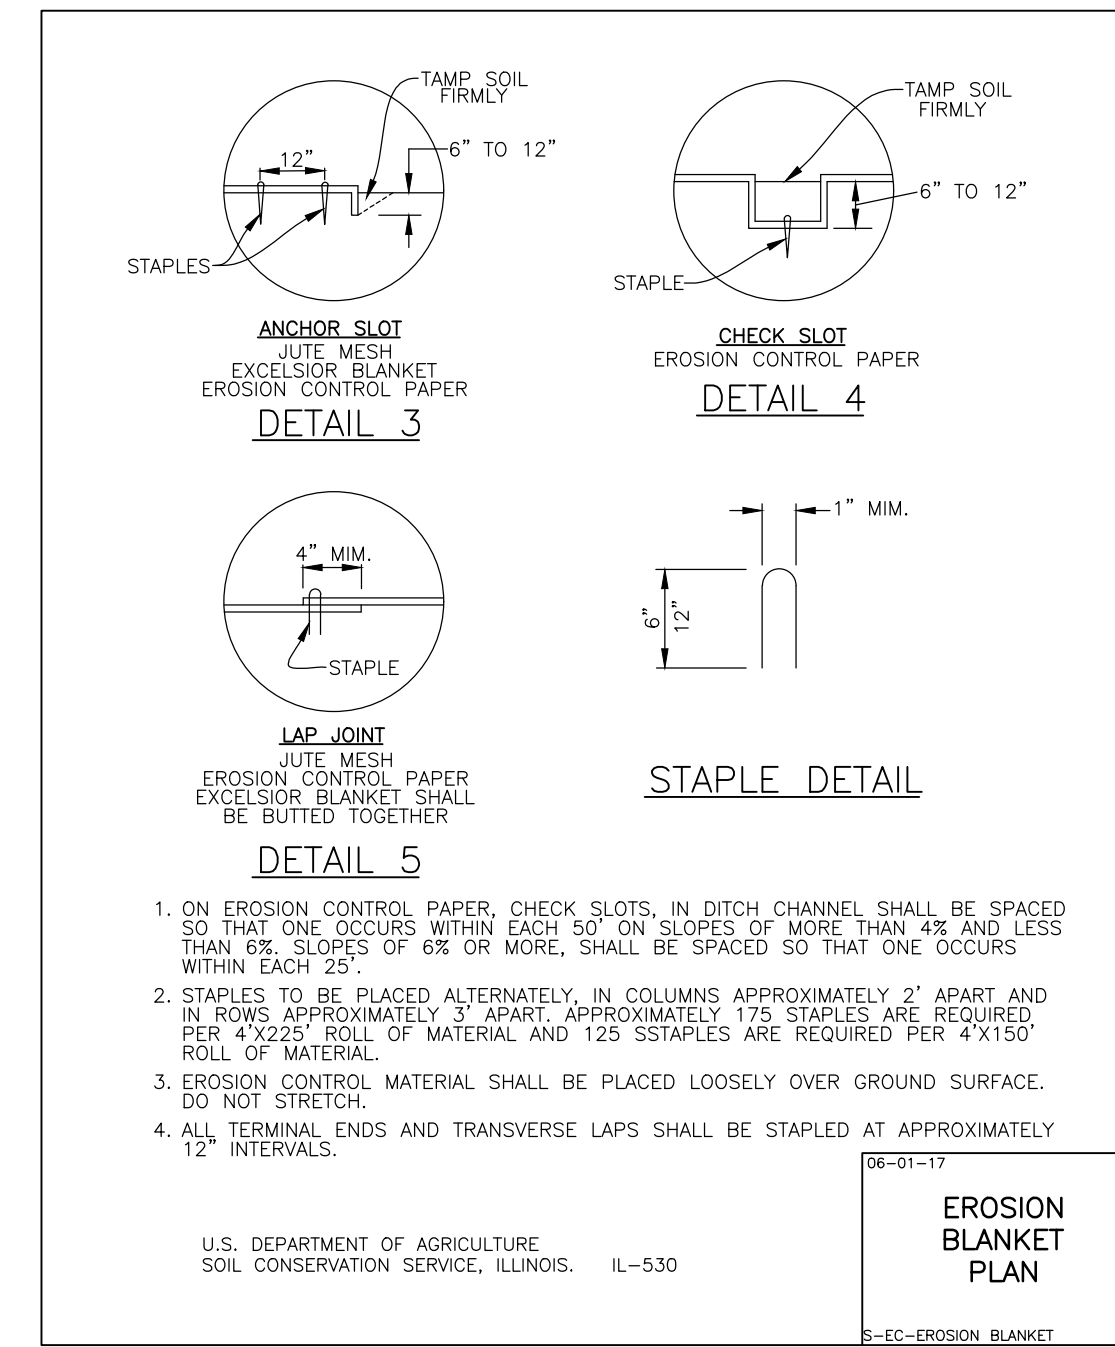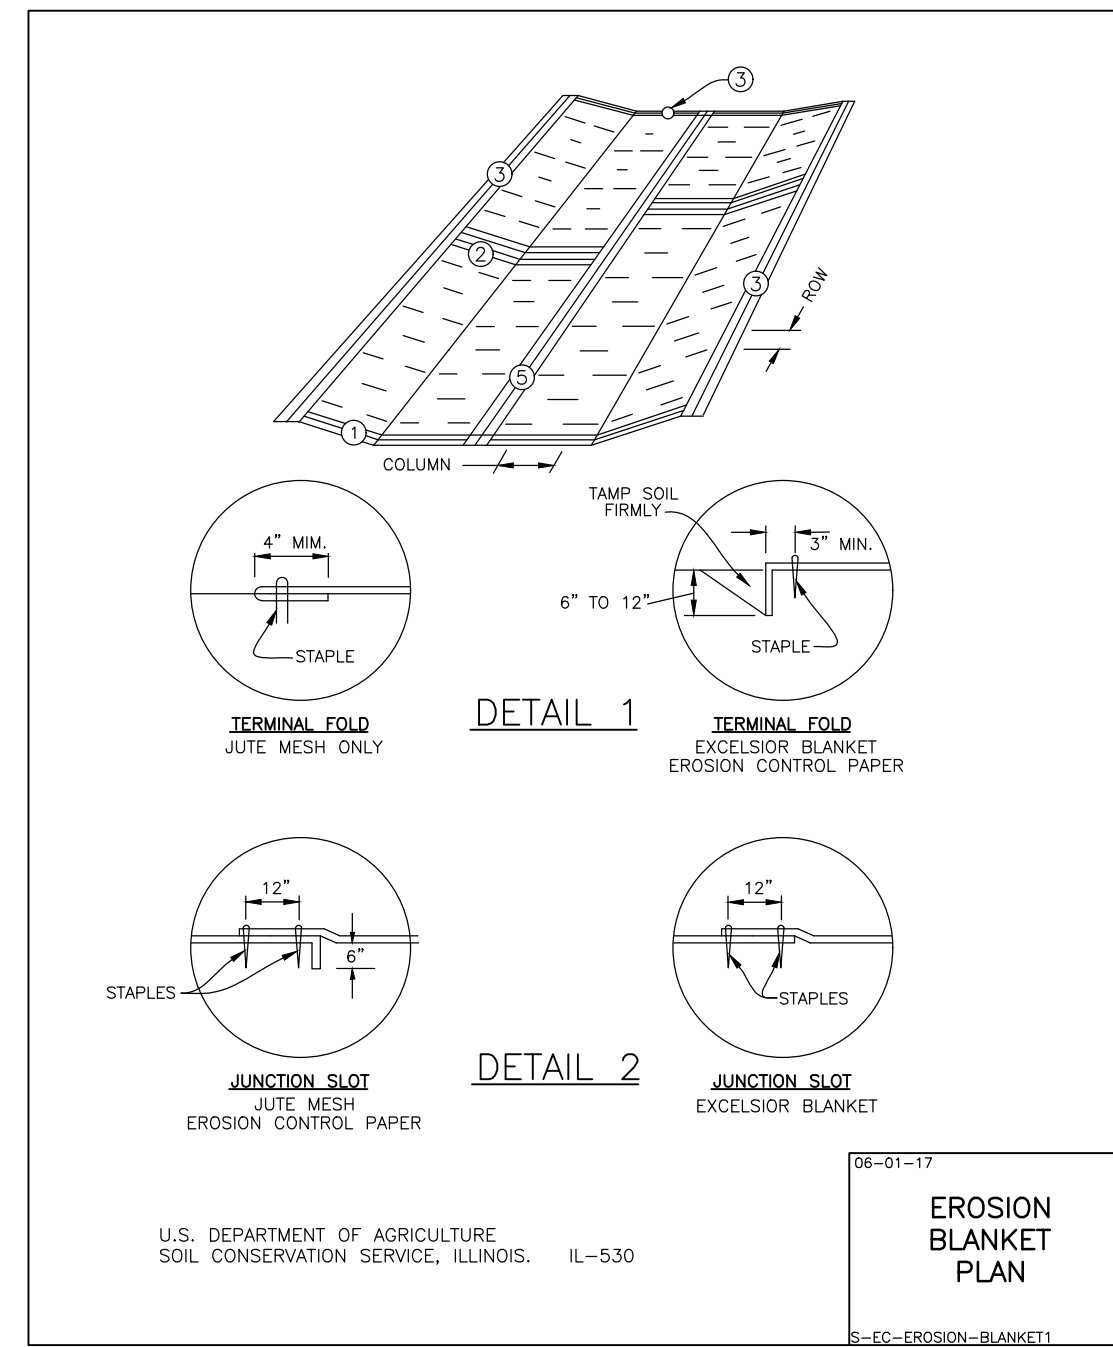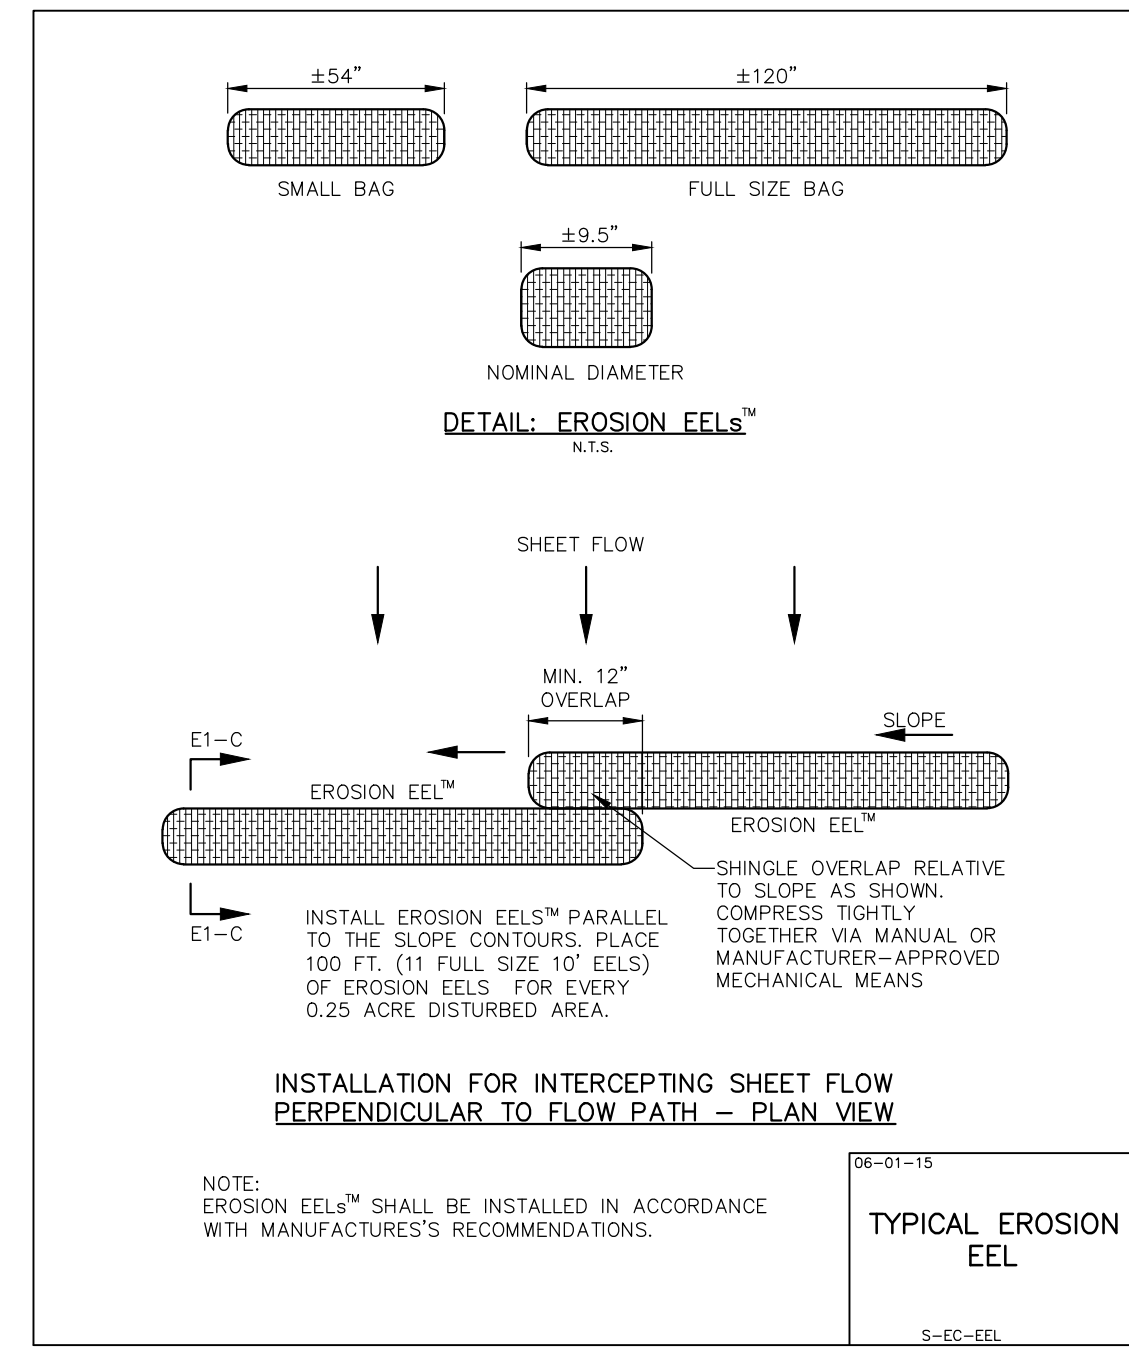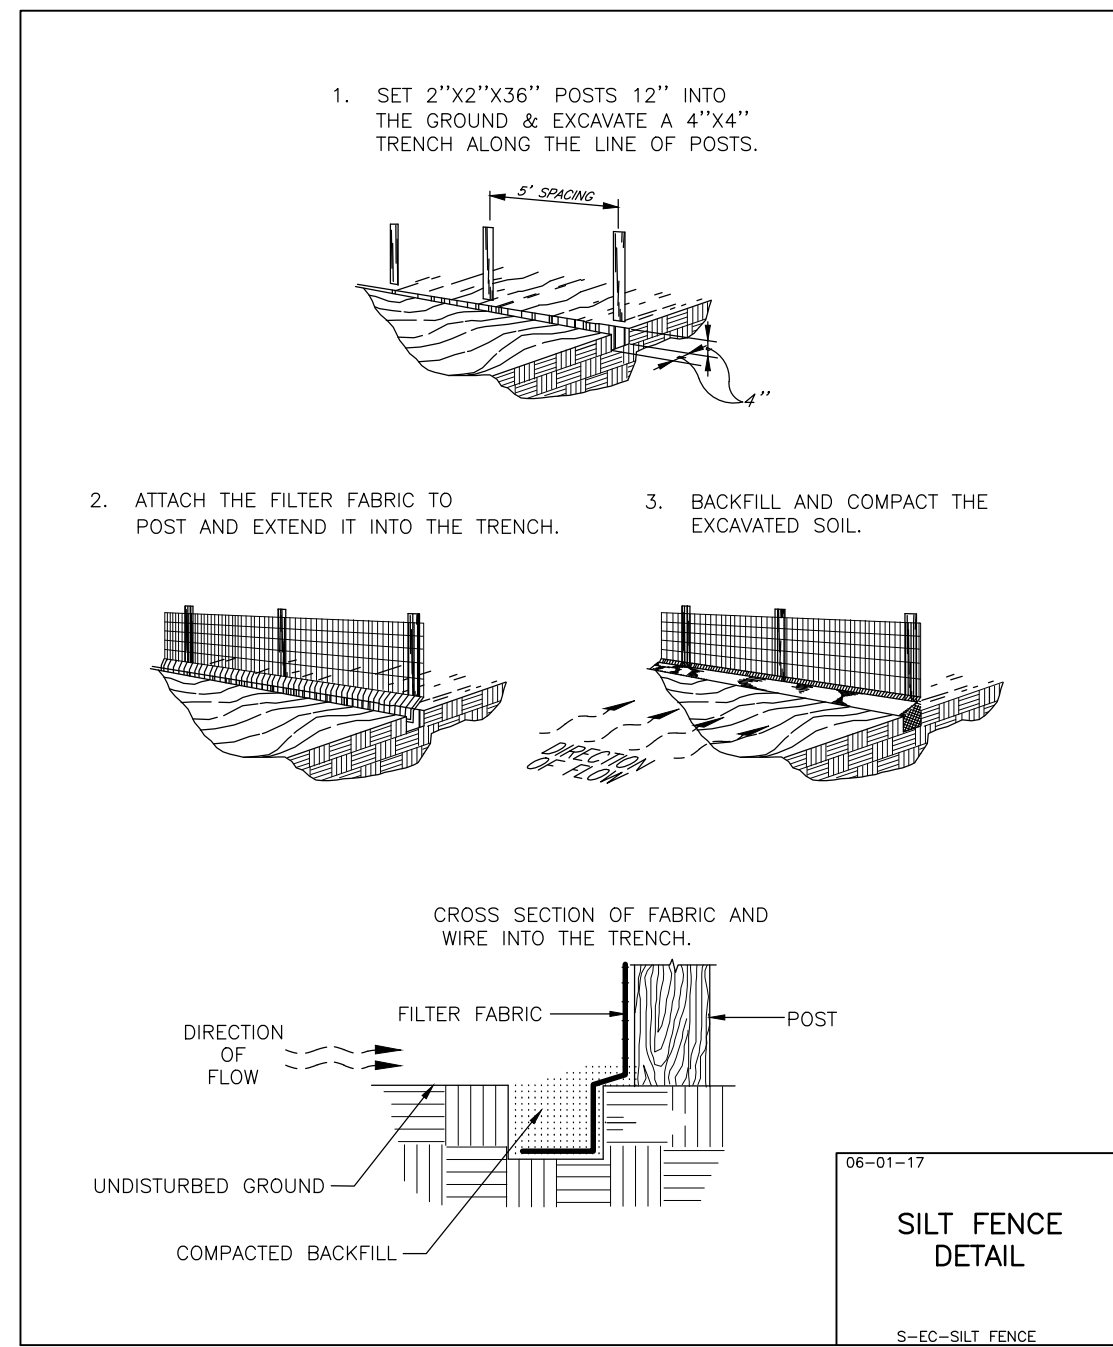

SHOULD A CONFLICT ARISE BETWEEN MANHARD DETAILS AND THE VILLAGE DETAILS, THE VILLAGE DETAILS SHALL TAKE PRECEDENCE.

February 16, 2021 - 16:02 Des Name: g:\vcsd\10\user\Erica\final drawings\Plan Set\18-SESQP-DETAILS.dwg Updated By: DMazzocco

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



PEDESTRIAN AND BICYCLE PATHWAY
OAKTON COMMUNITY COLLEGE - DES PLAINES CAMPUS
SOIL EROSION AND SEDIMENT CONTROL PLAN - DETAILS











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ISSUED FOR BID

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DATE	REVISIONS
12-23-22	REVISED FOR BIDS
11-10-21	ISSUED FOR BIDS

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PEDESTRIAN AND BICYCLE PATHWAY
OAKTON COMMUNITY COLLEGE - DES PLAINES CAMPUS
CROSS-SECTIONS - STA. 5+50 TO STA. 10+00











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ISSUED FOR BID

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LEGEND	
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	100-YR CUT

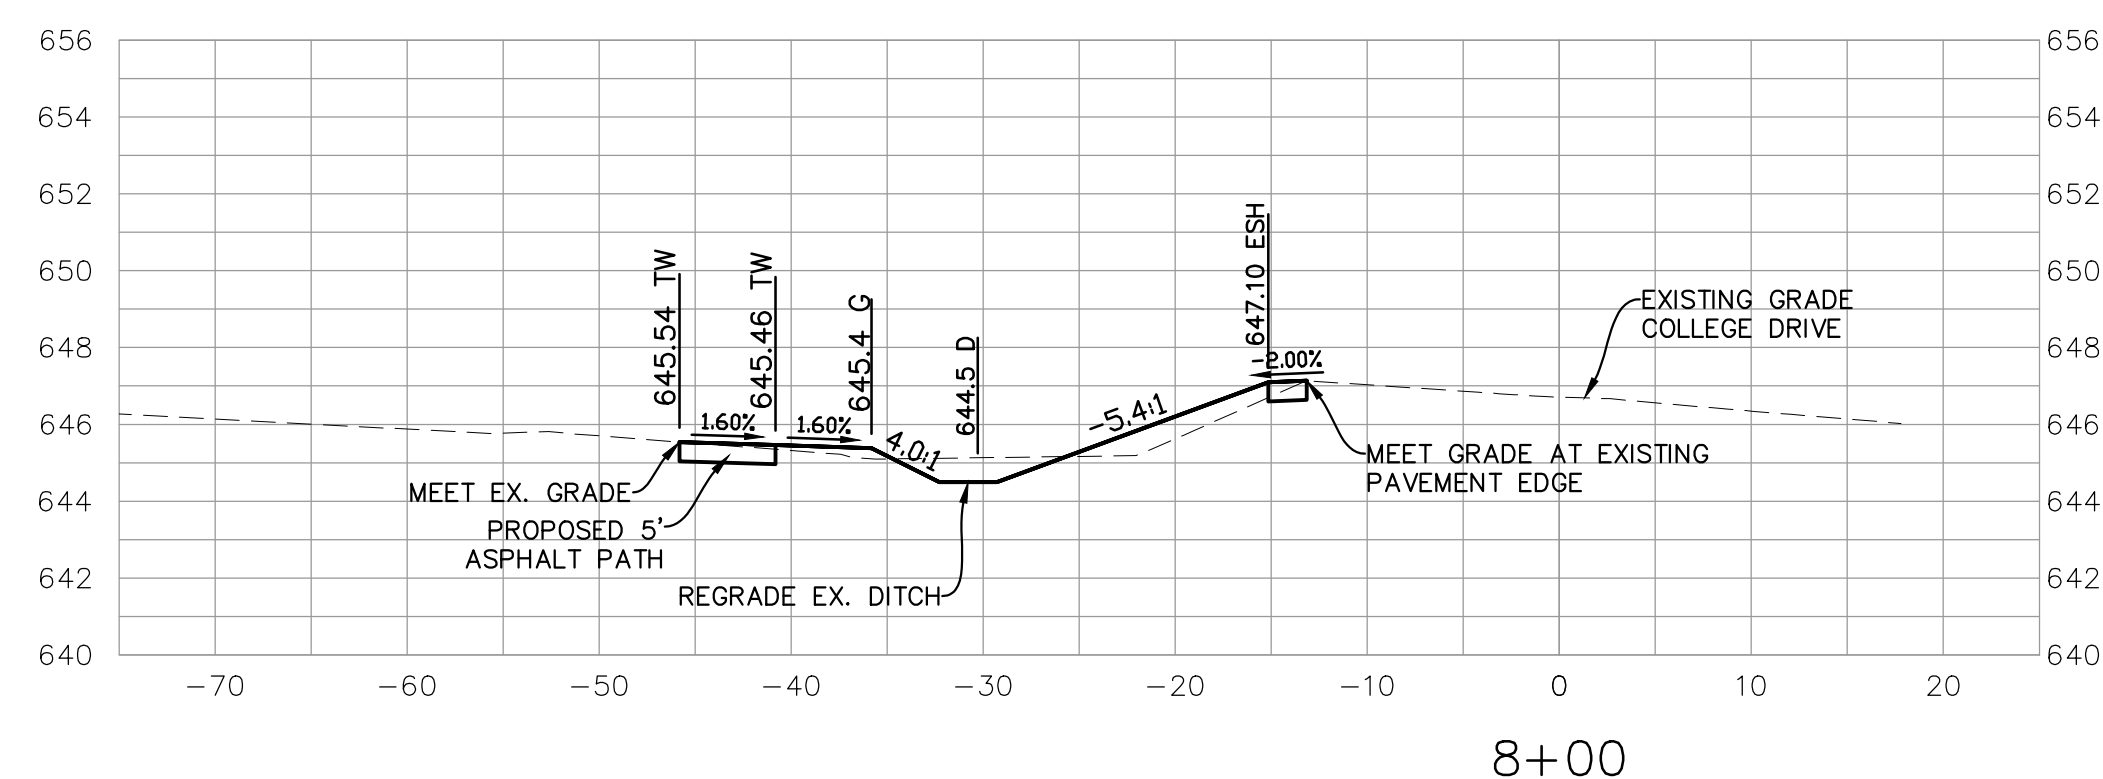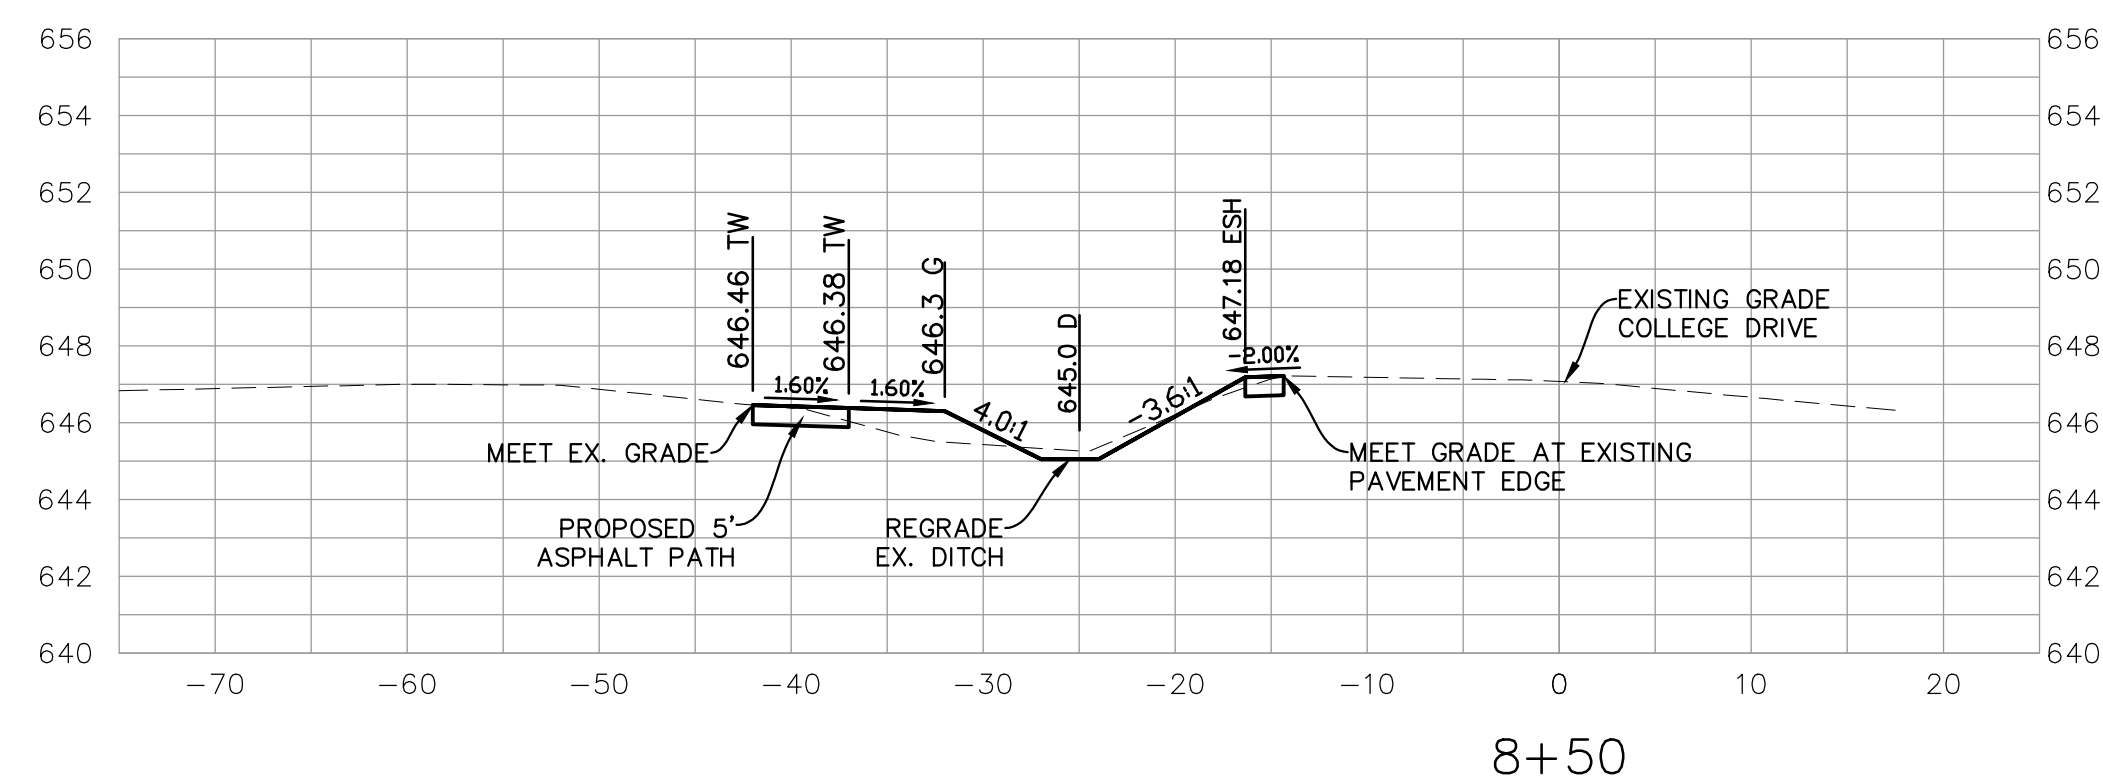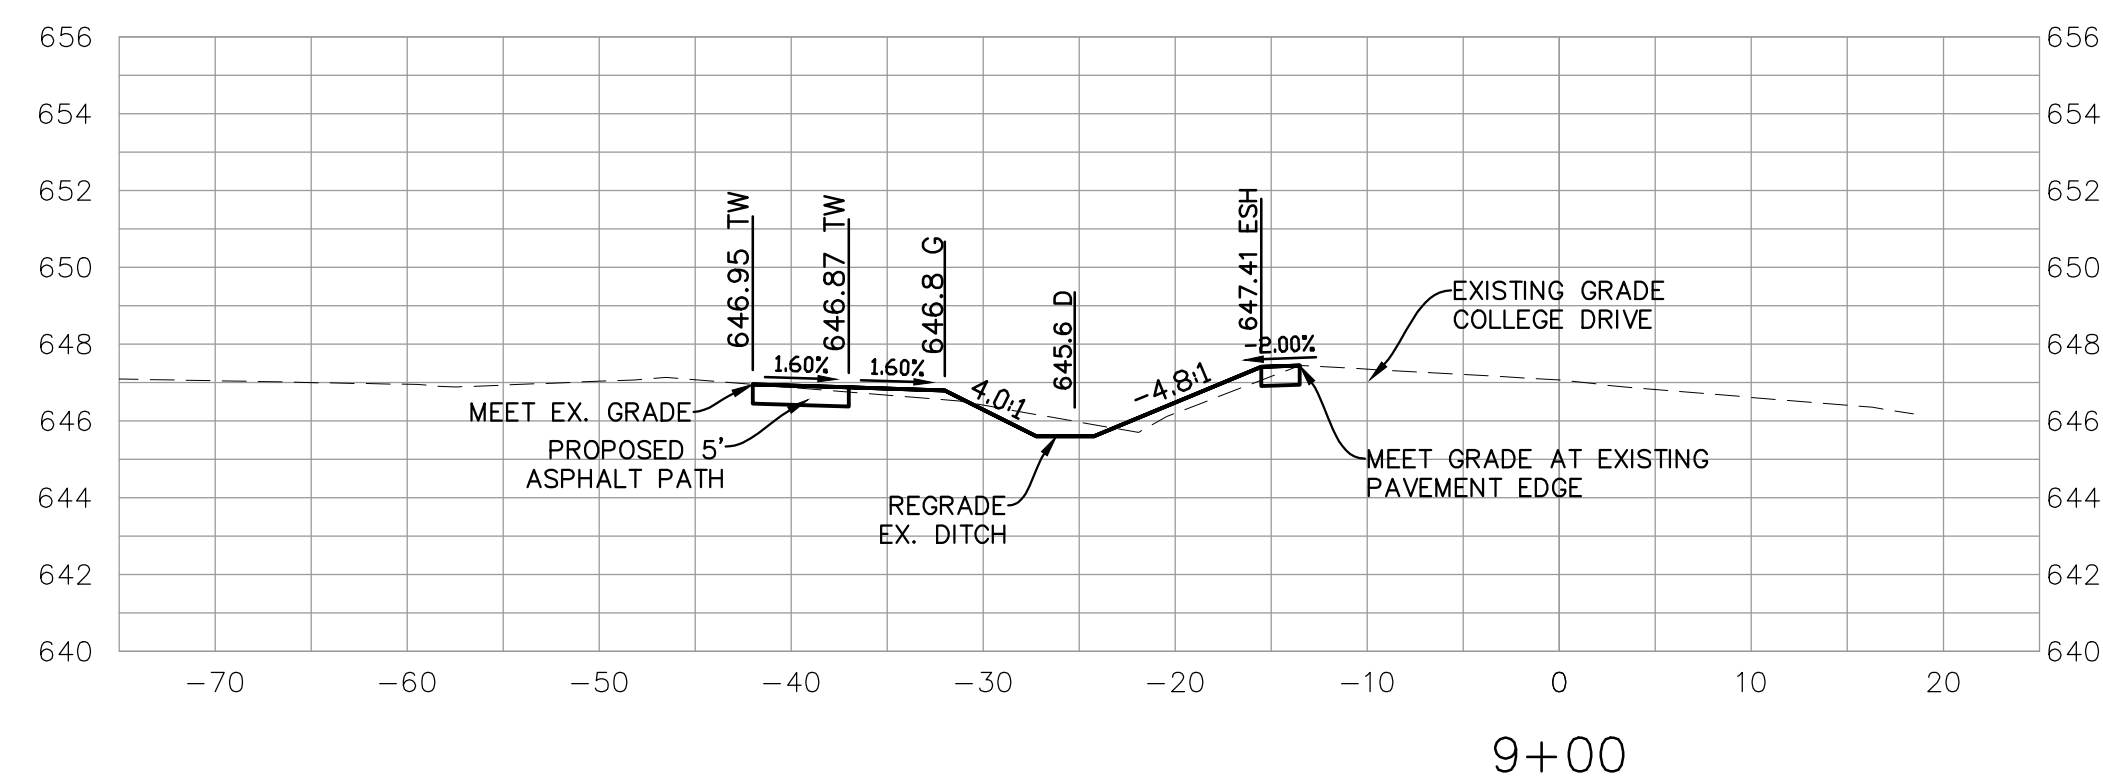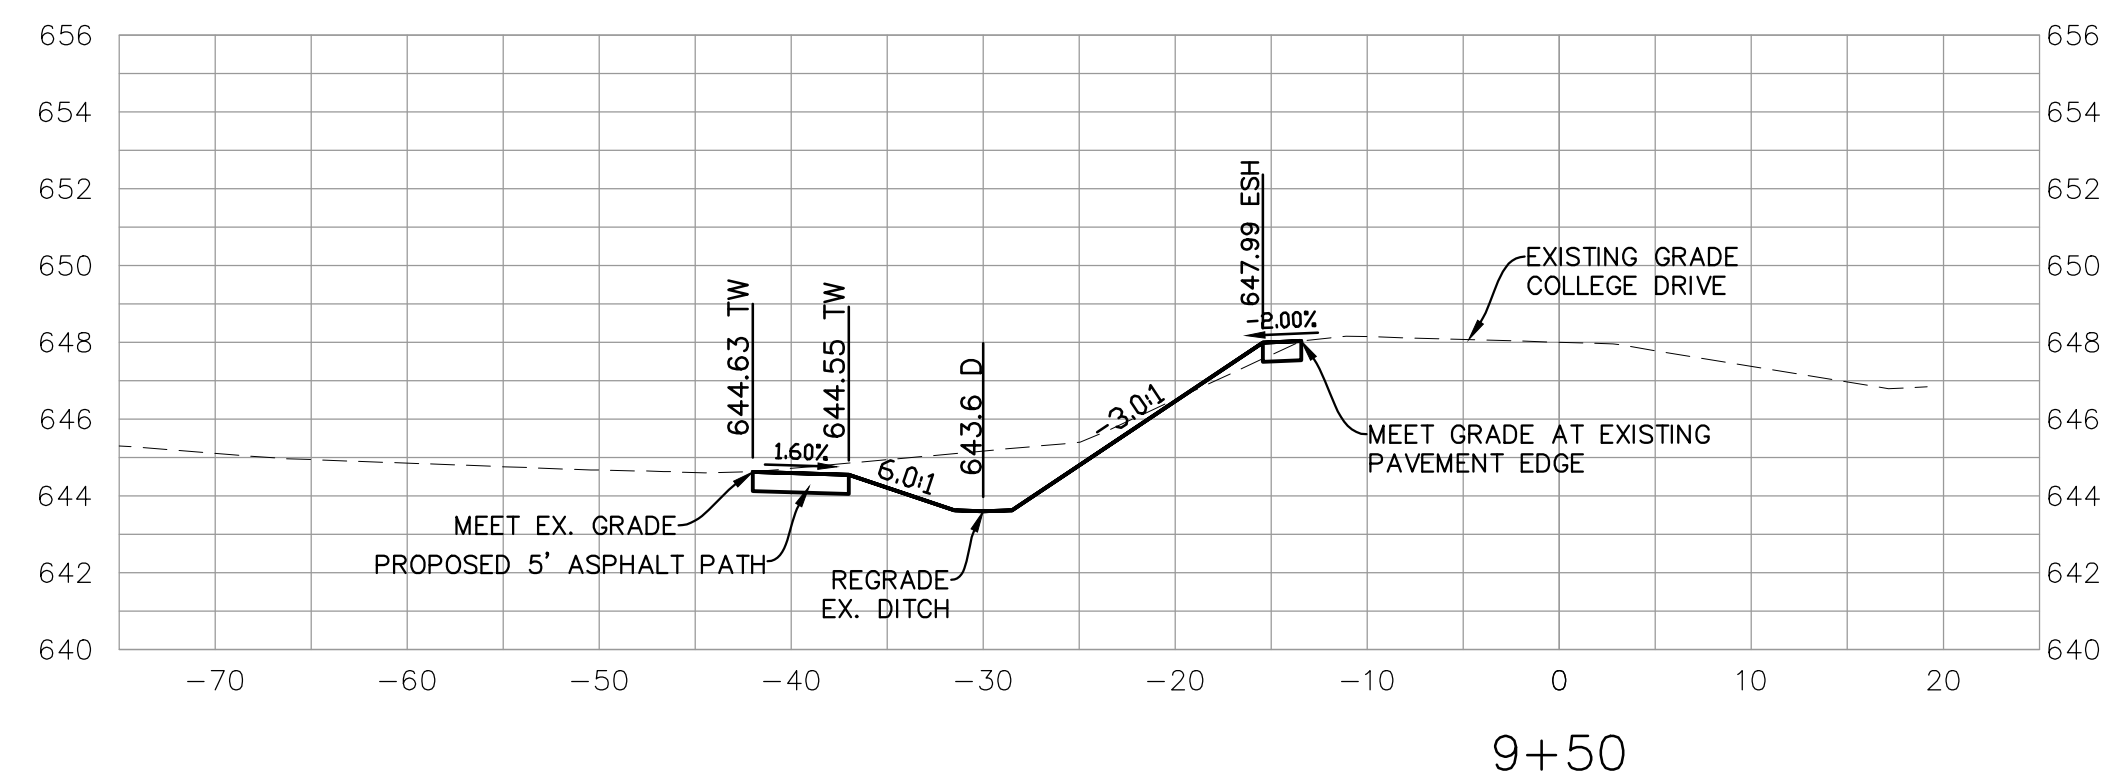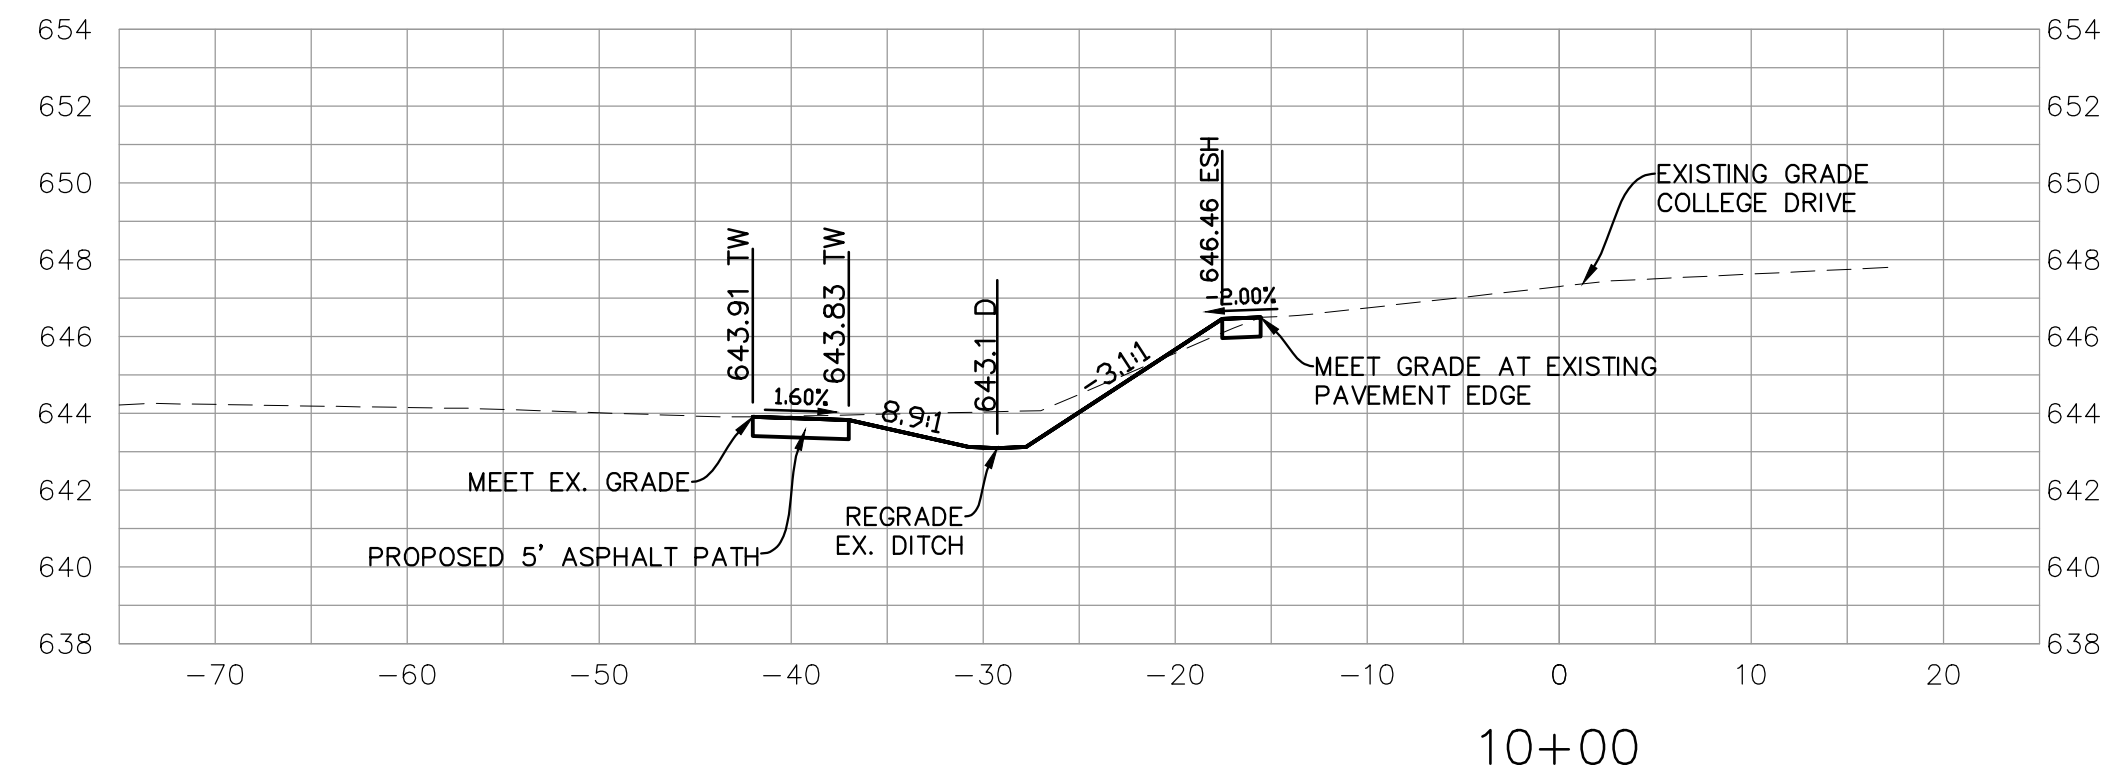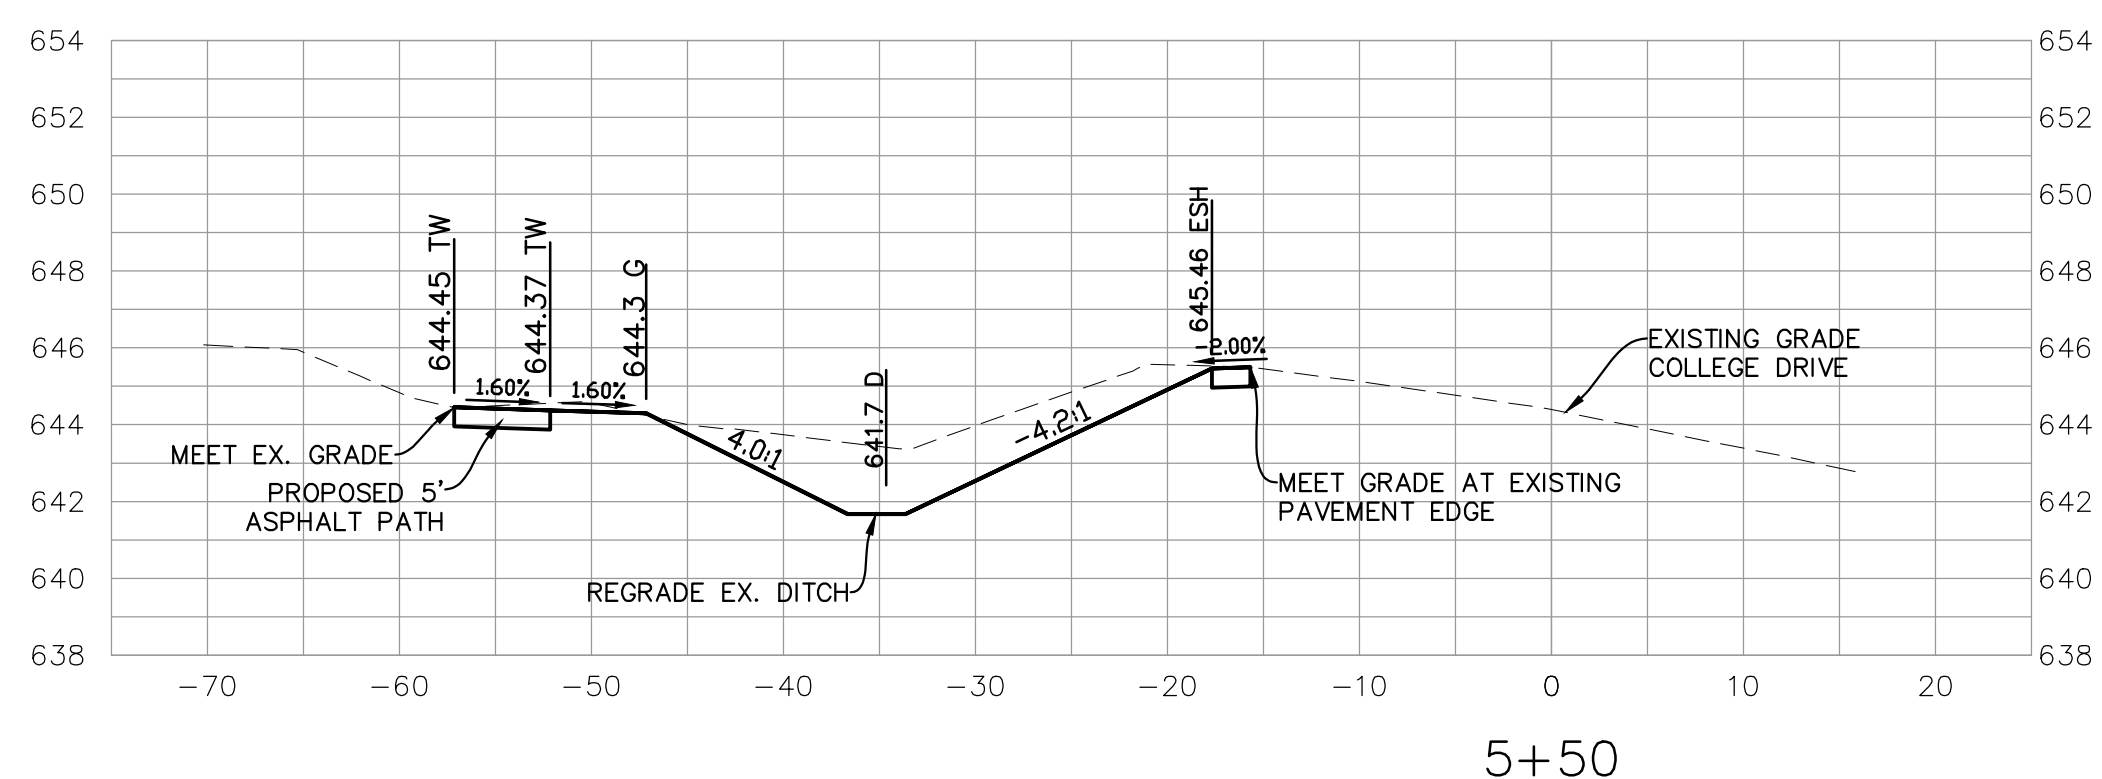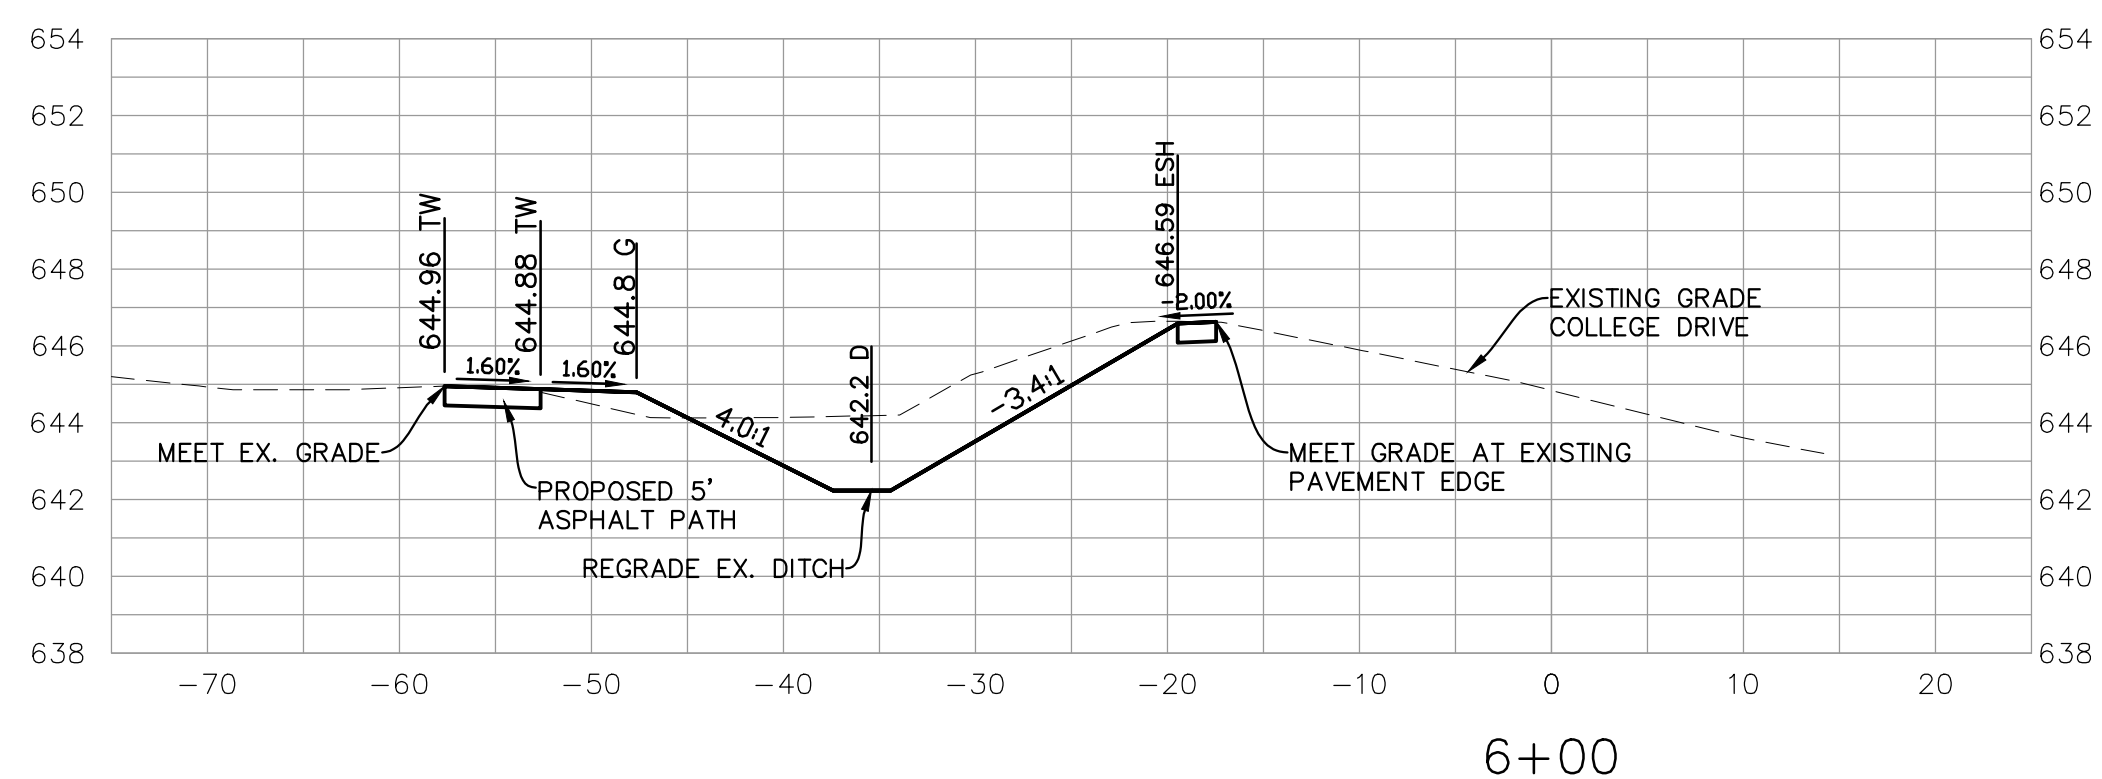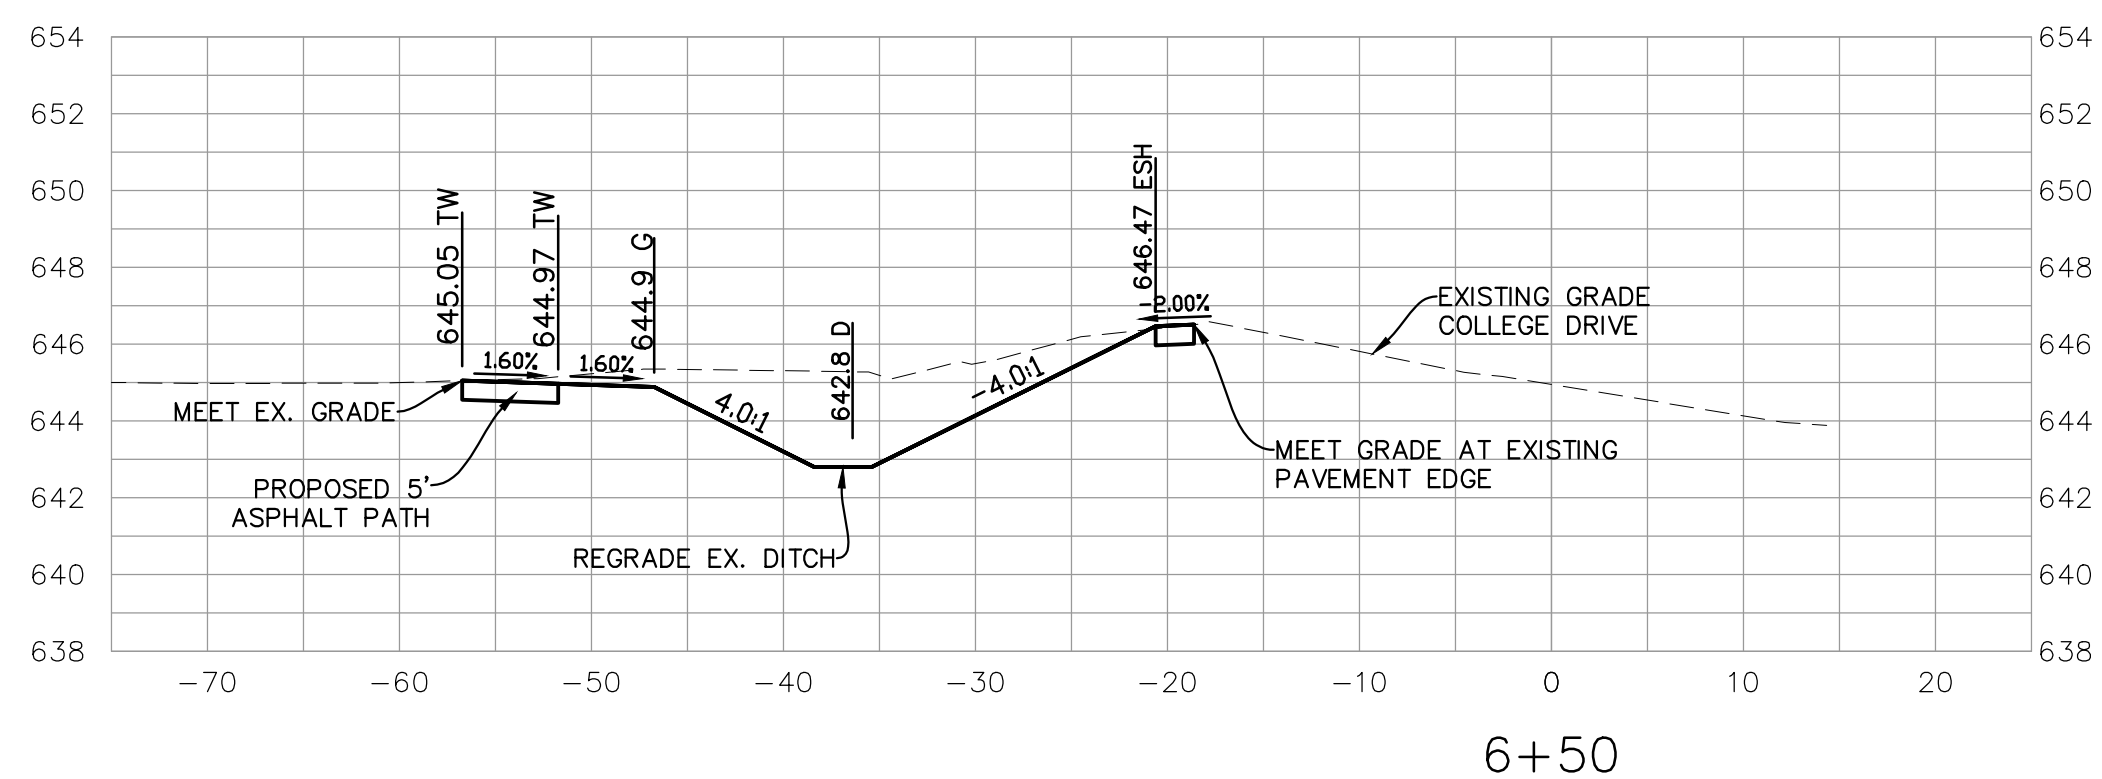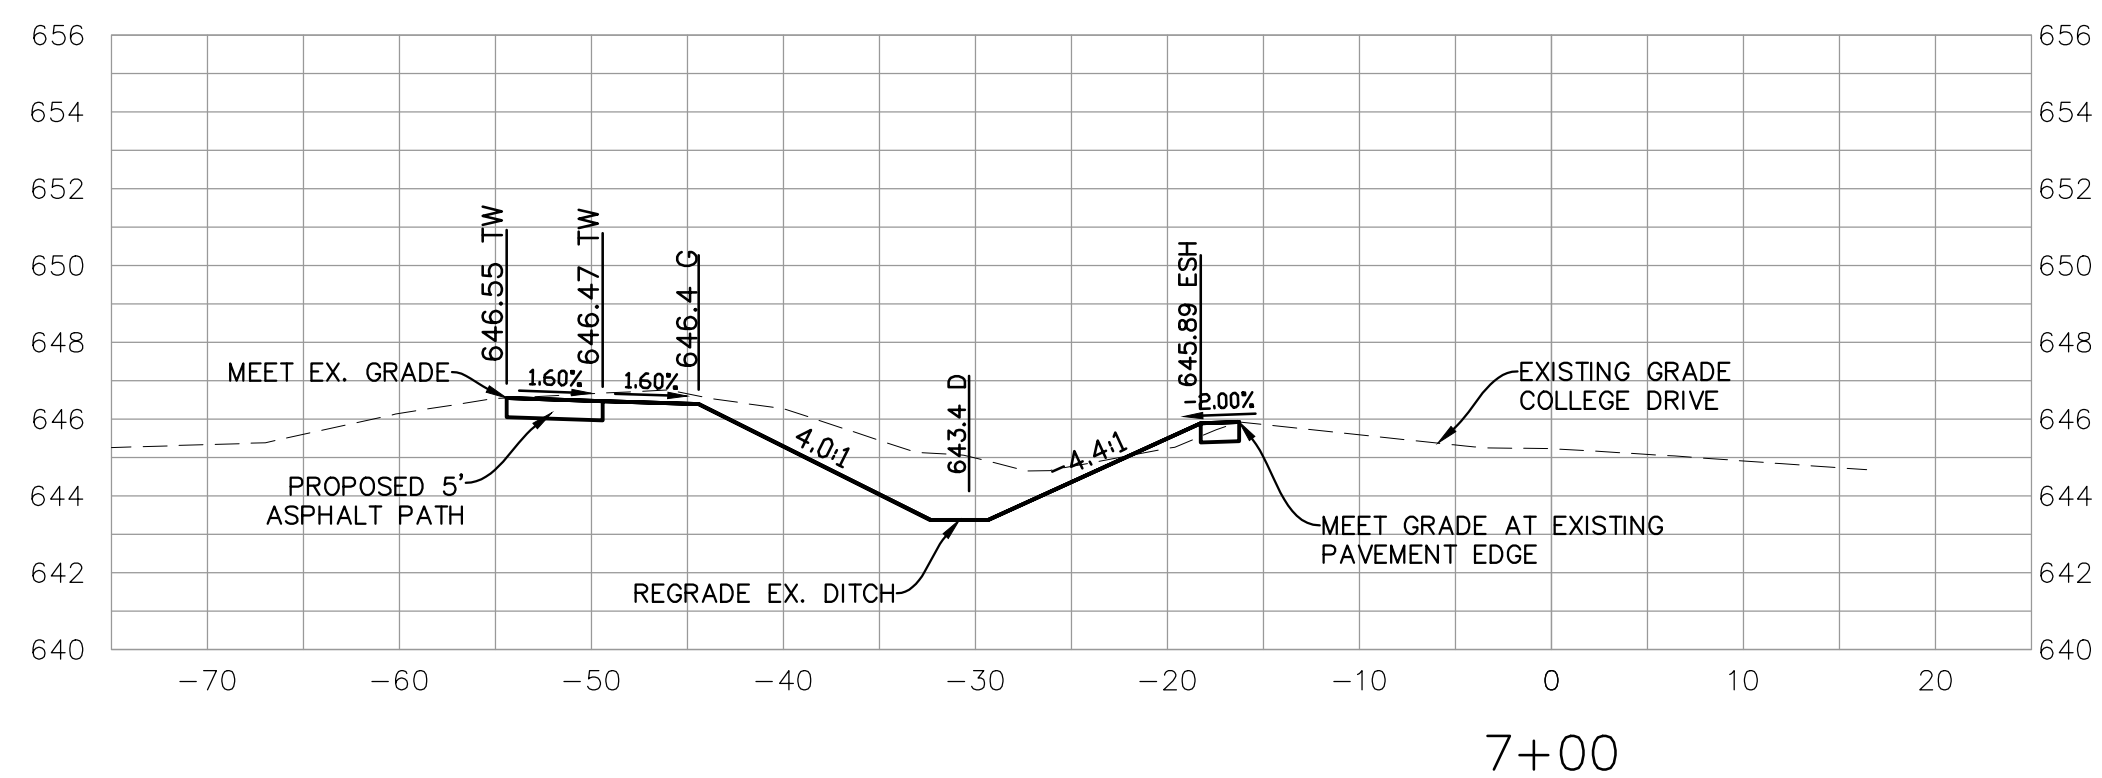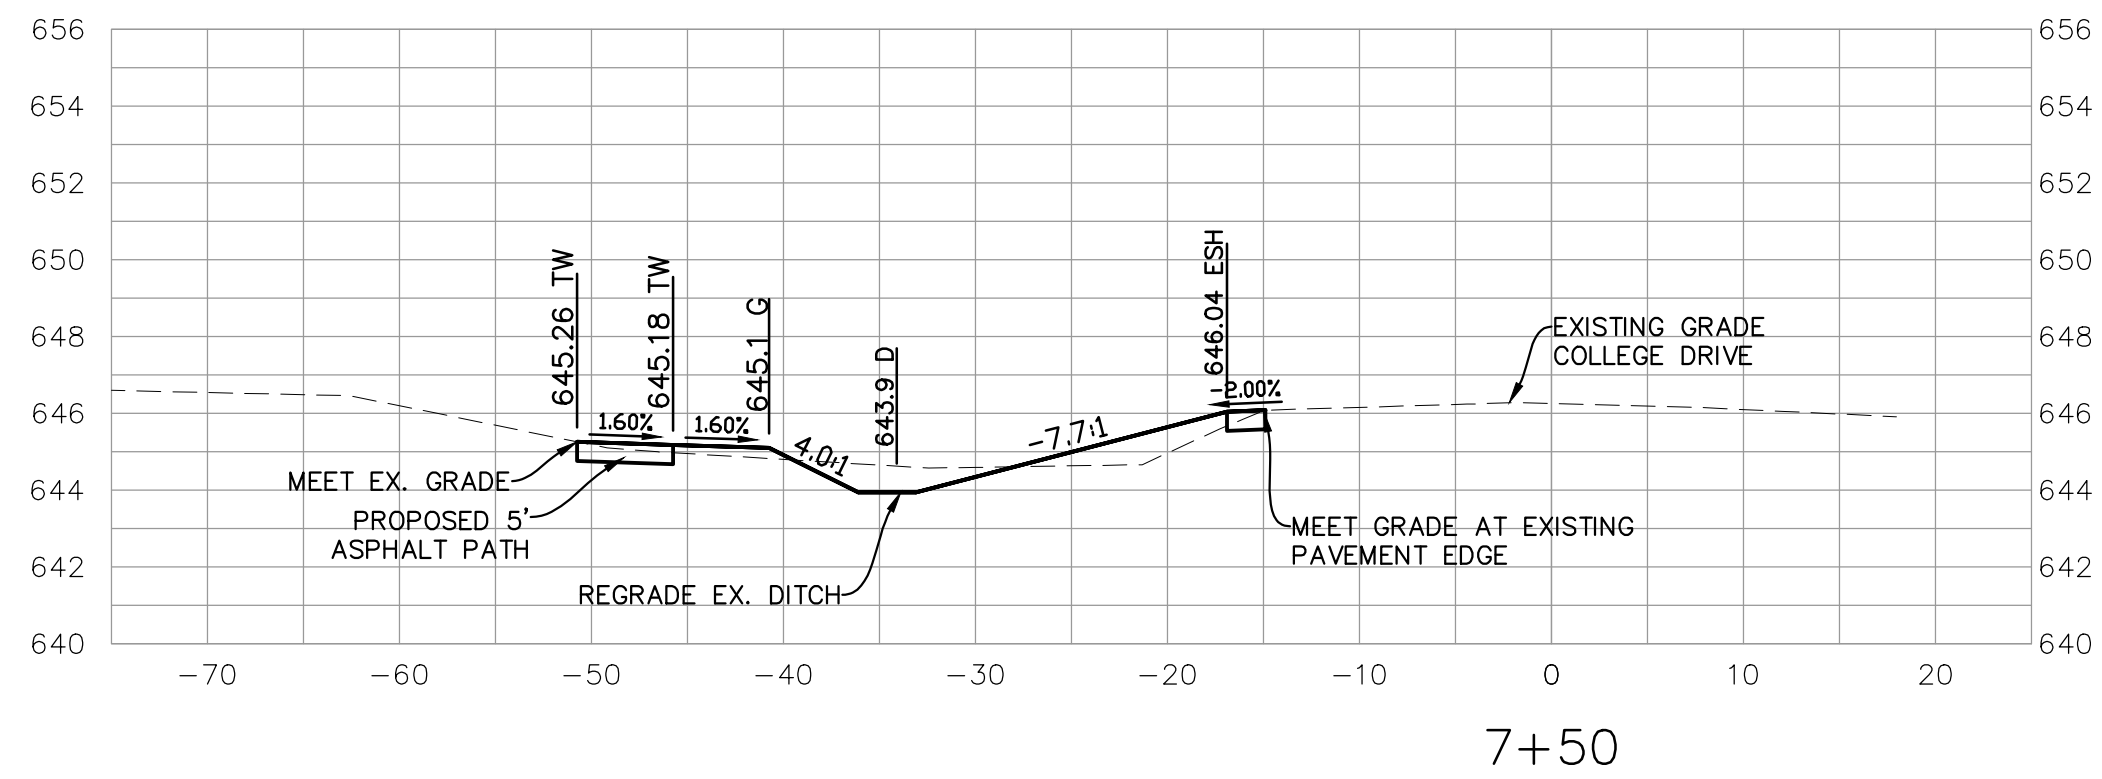

DATE	REVISIONS
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01-19-22	REVISED FOR METAL CABLE GAUGE RAIL
11-10-21	ISSUED FOR BIDS



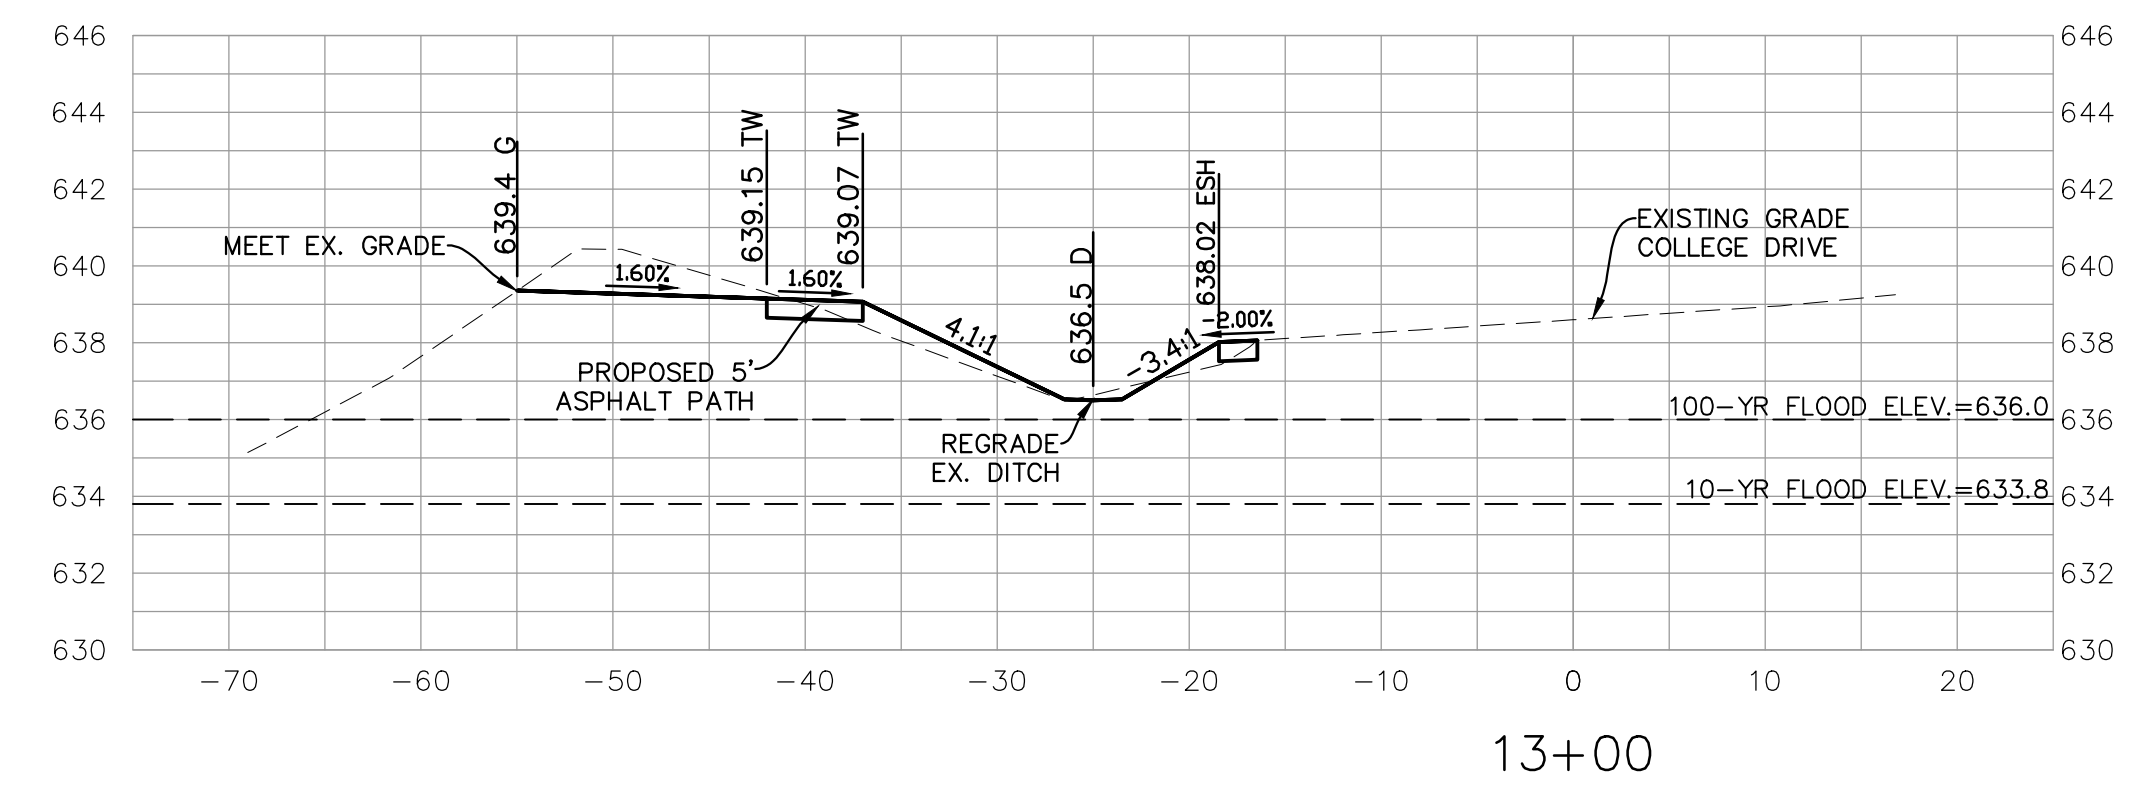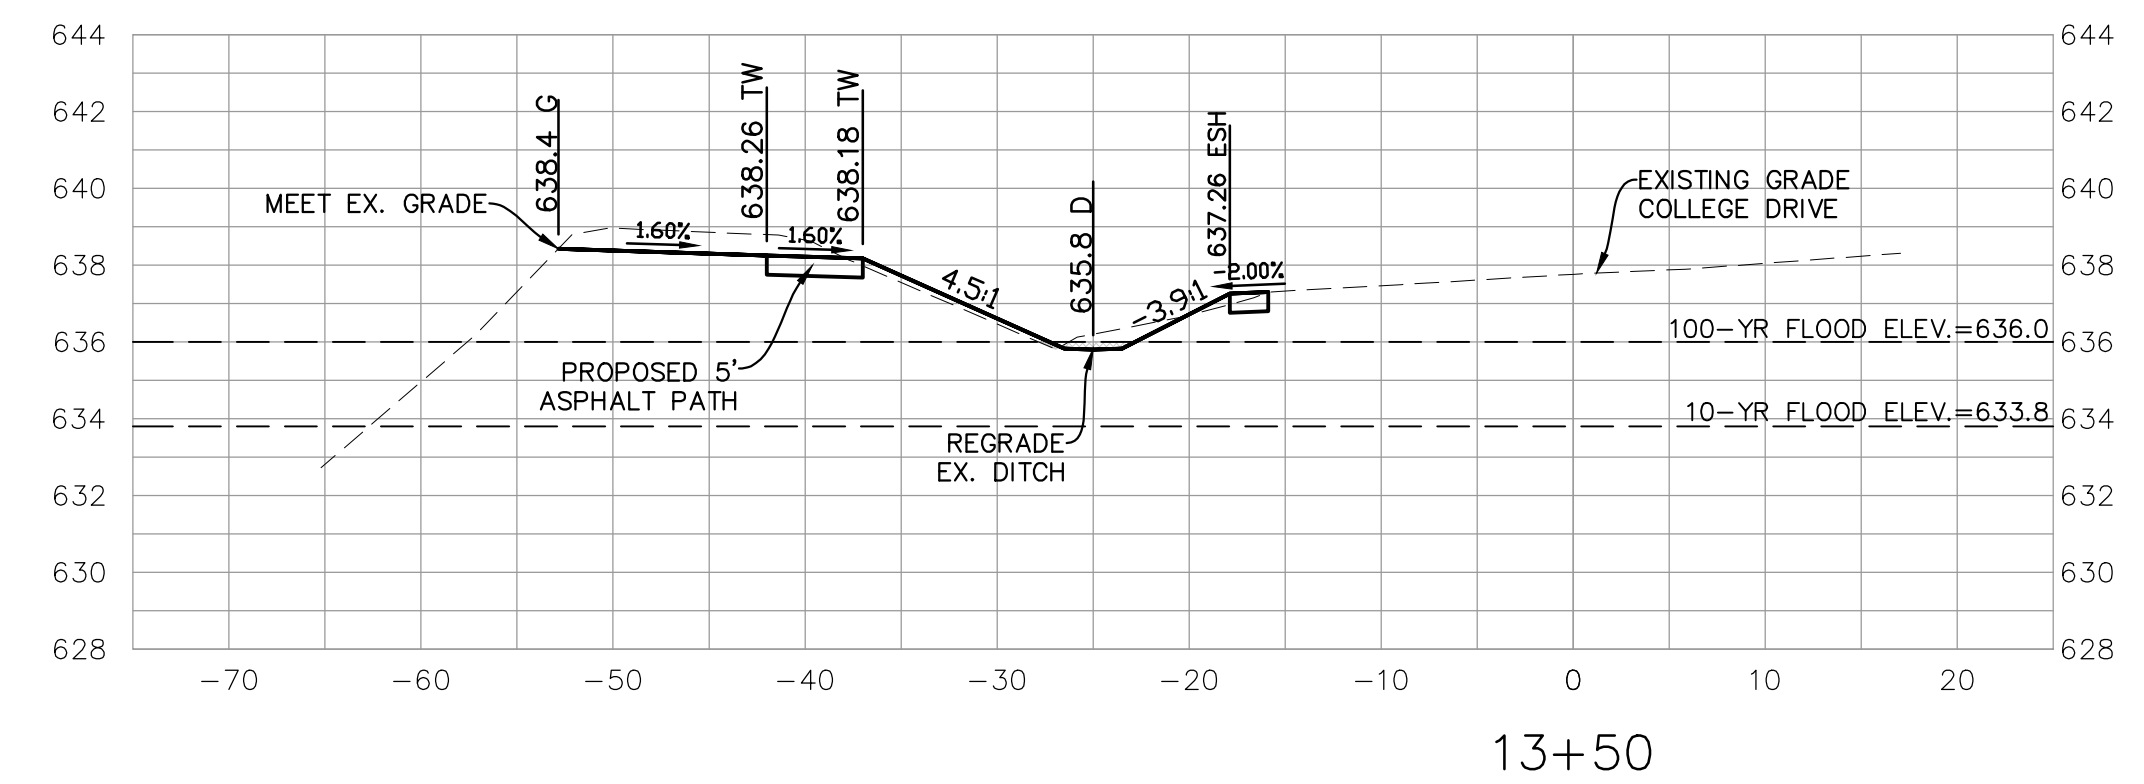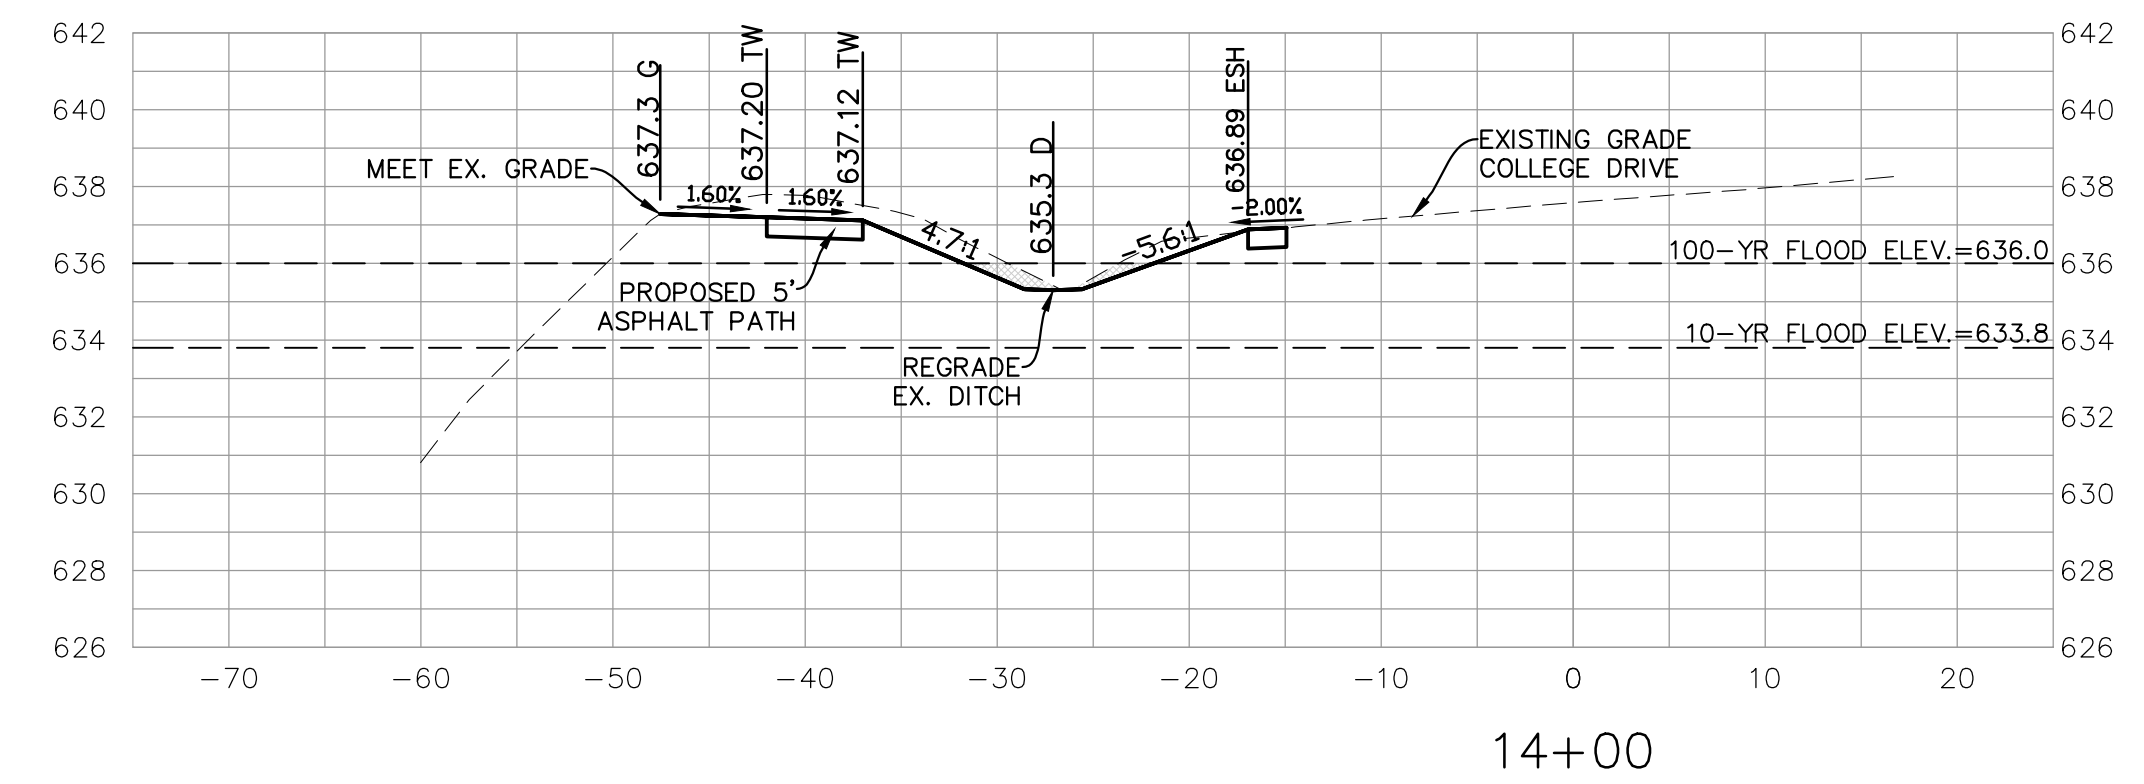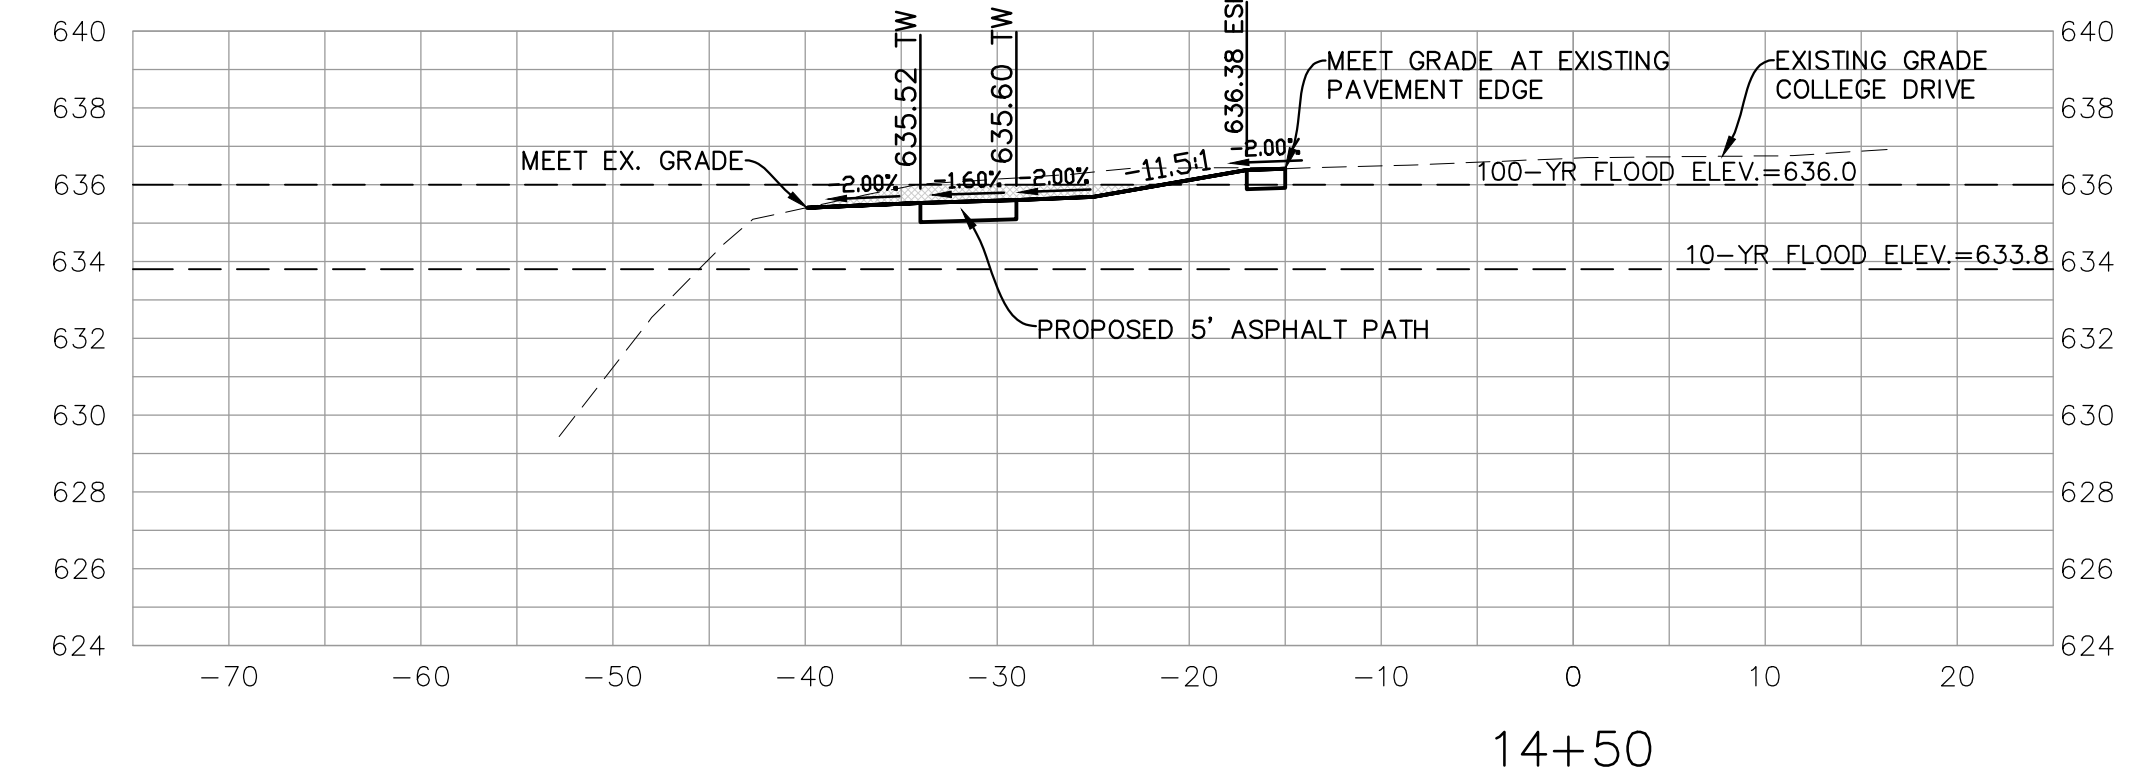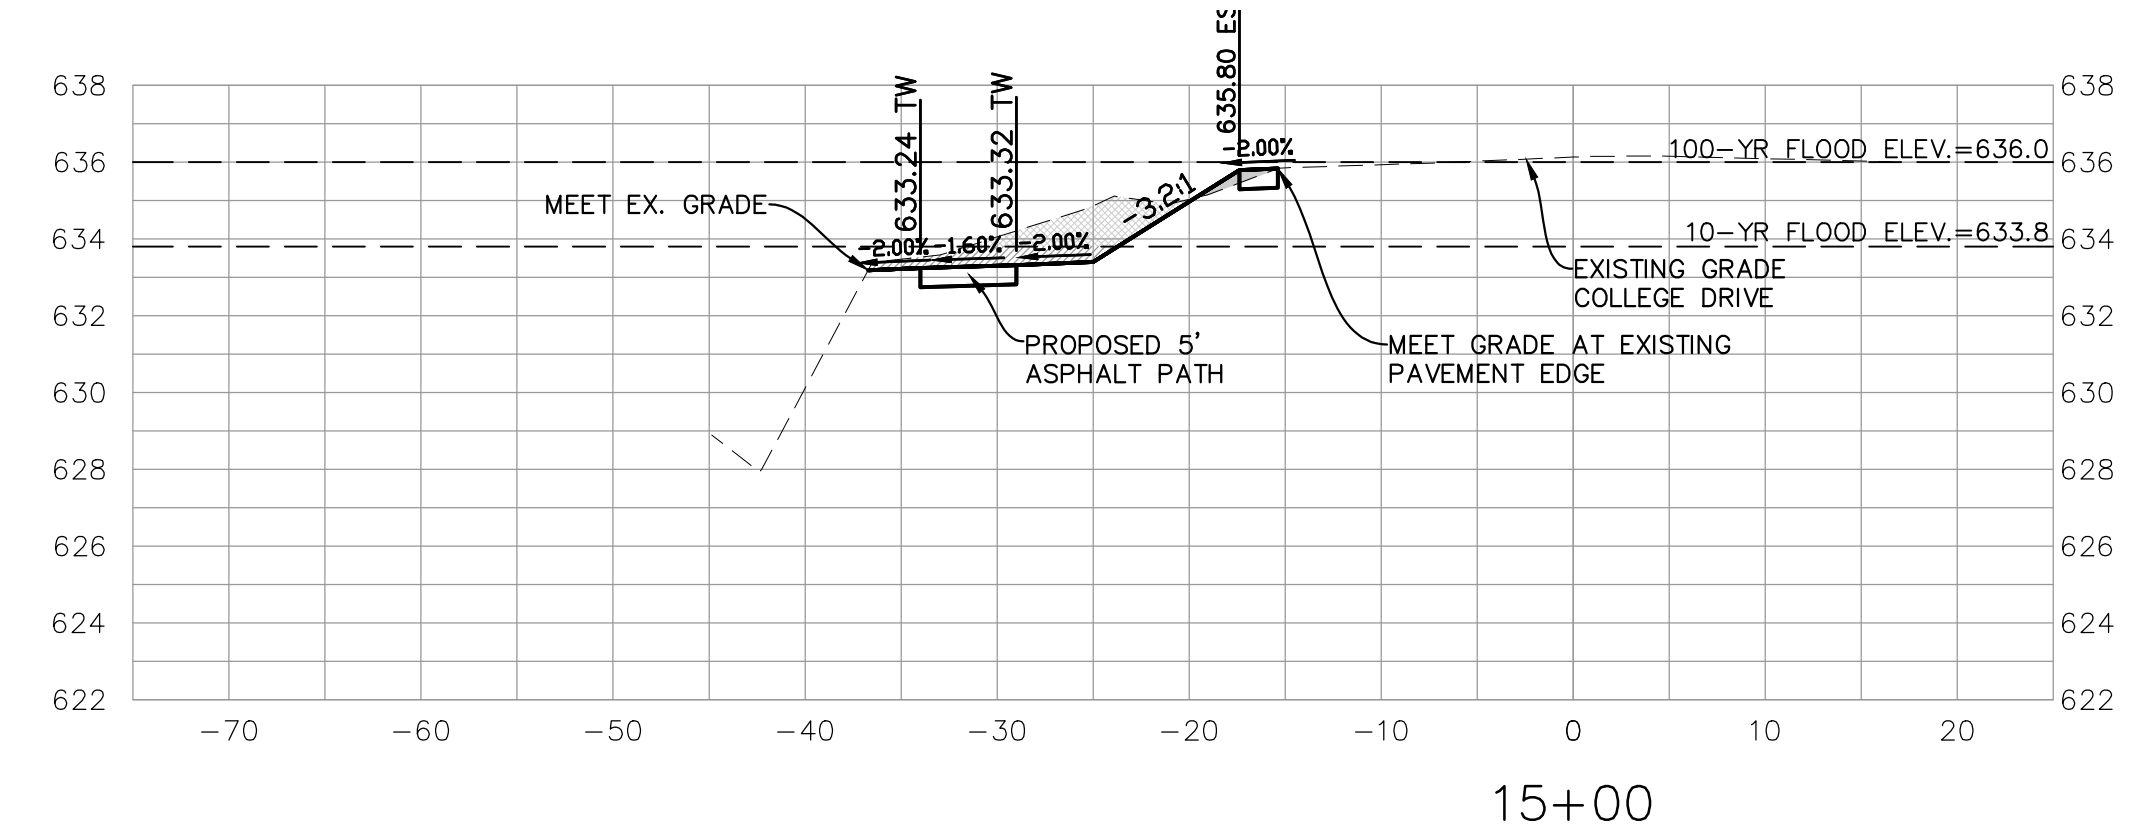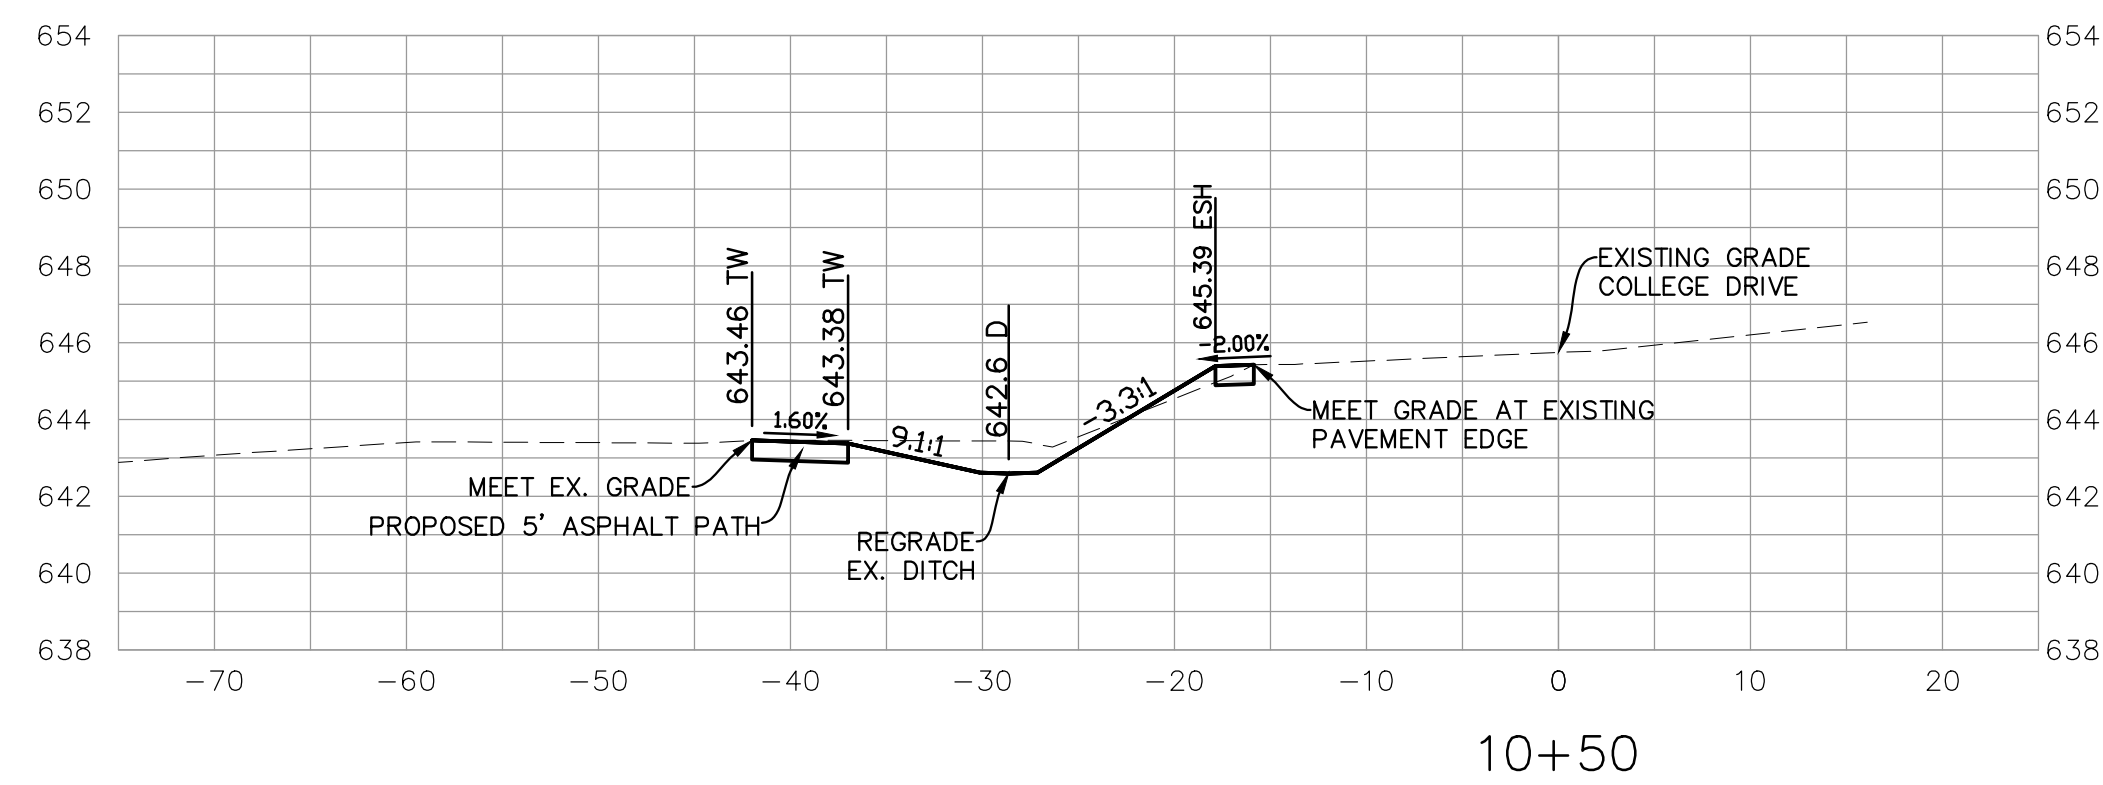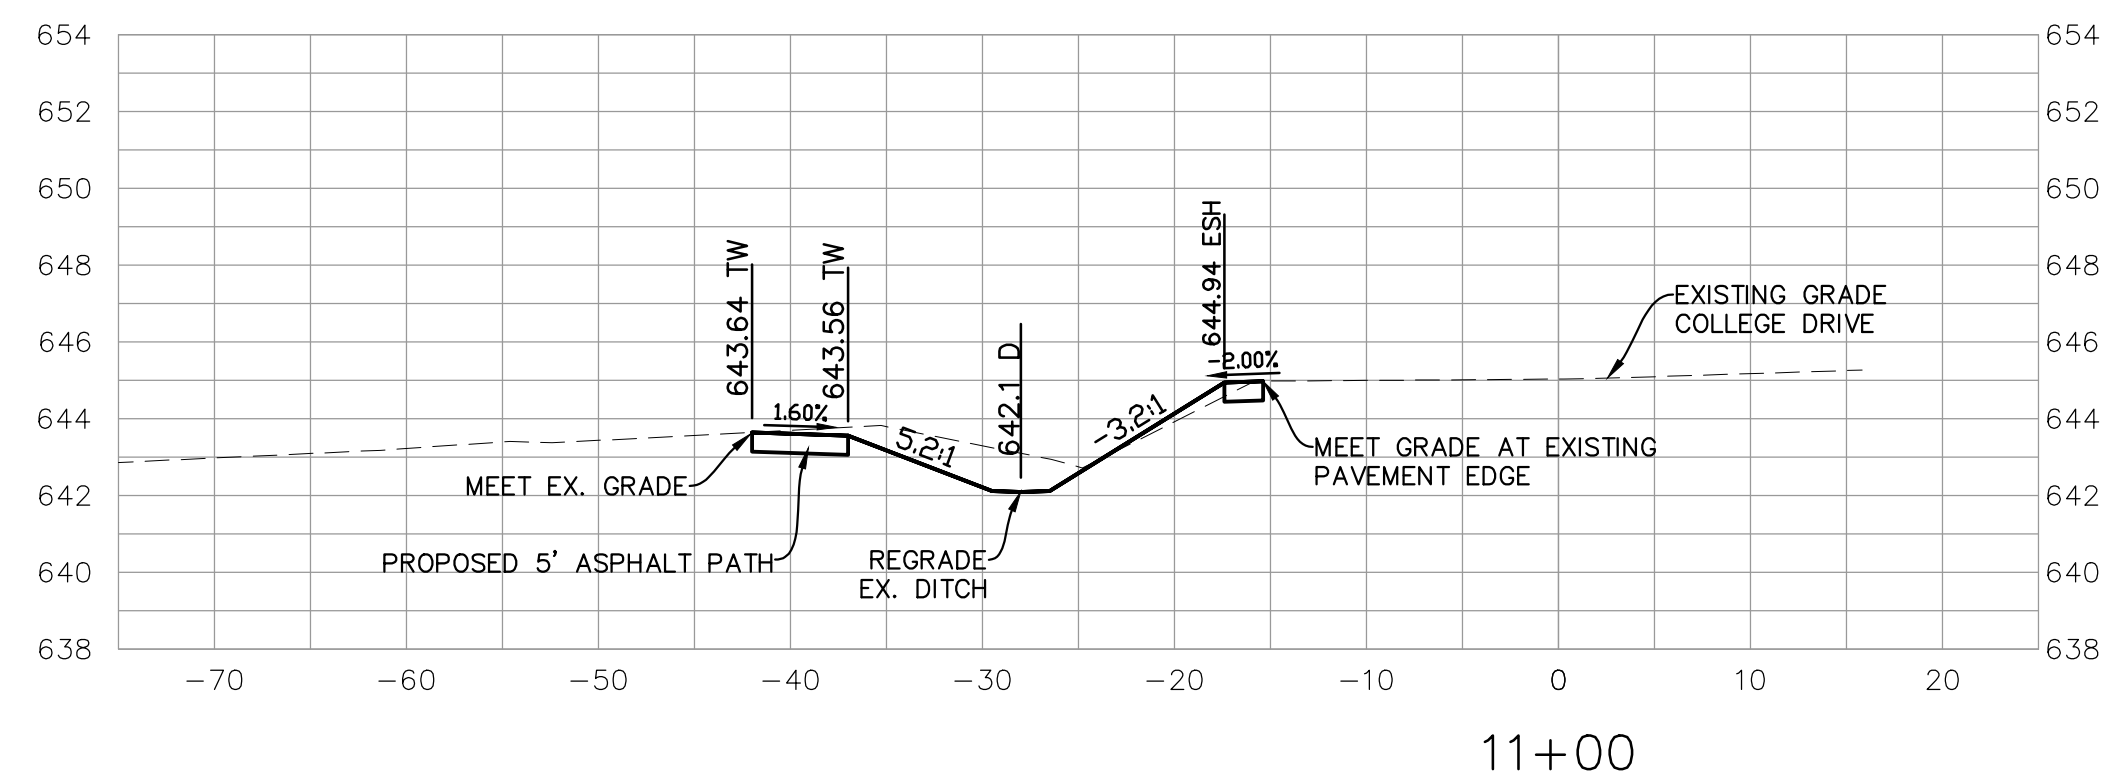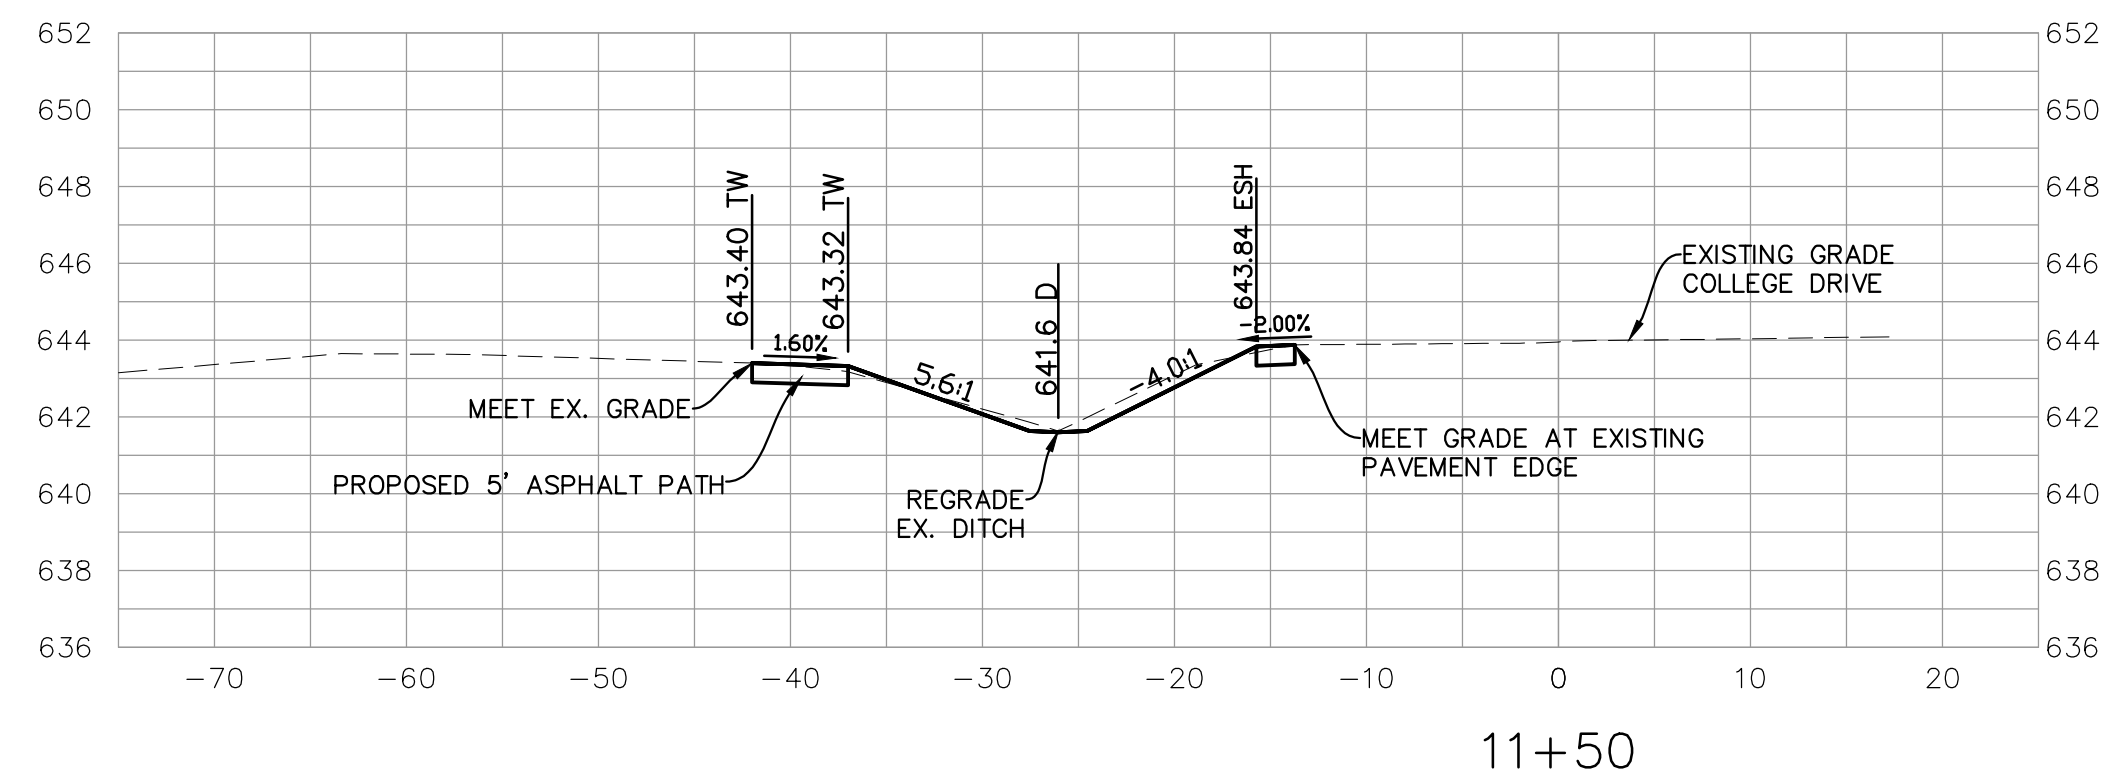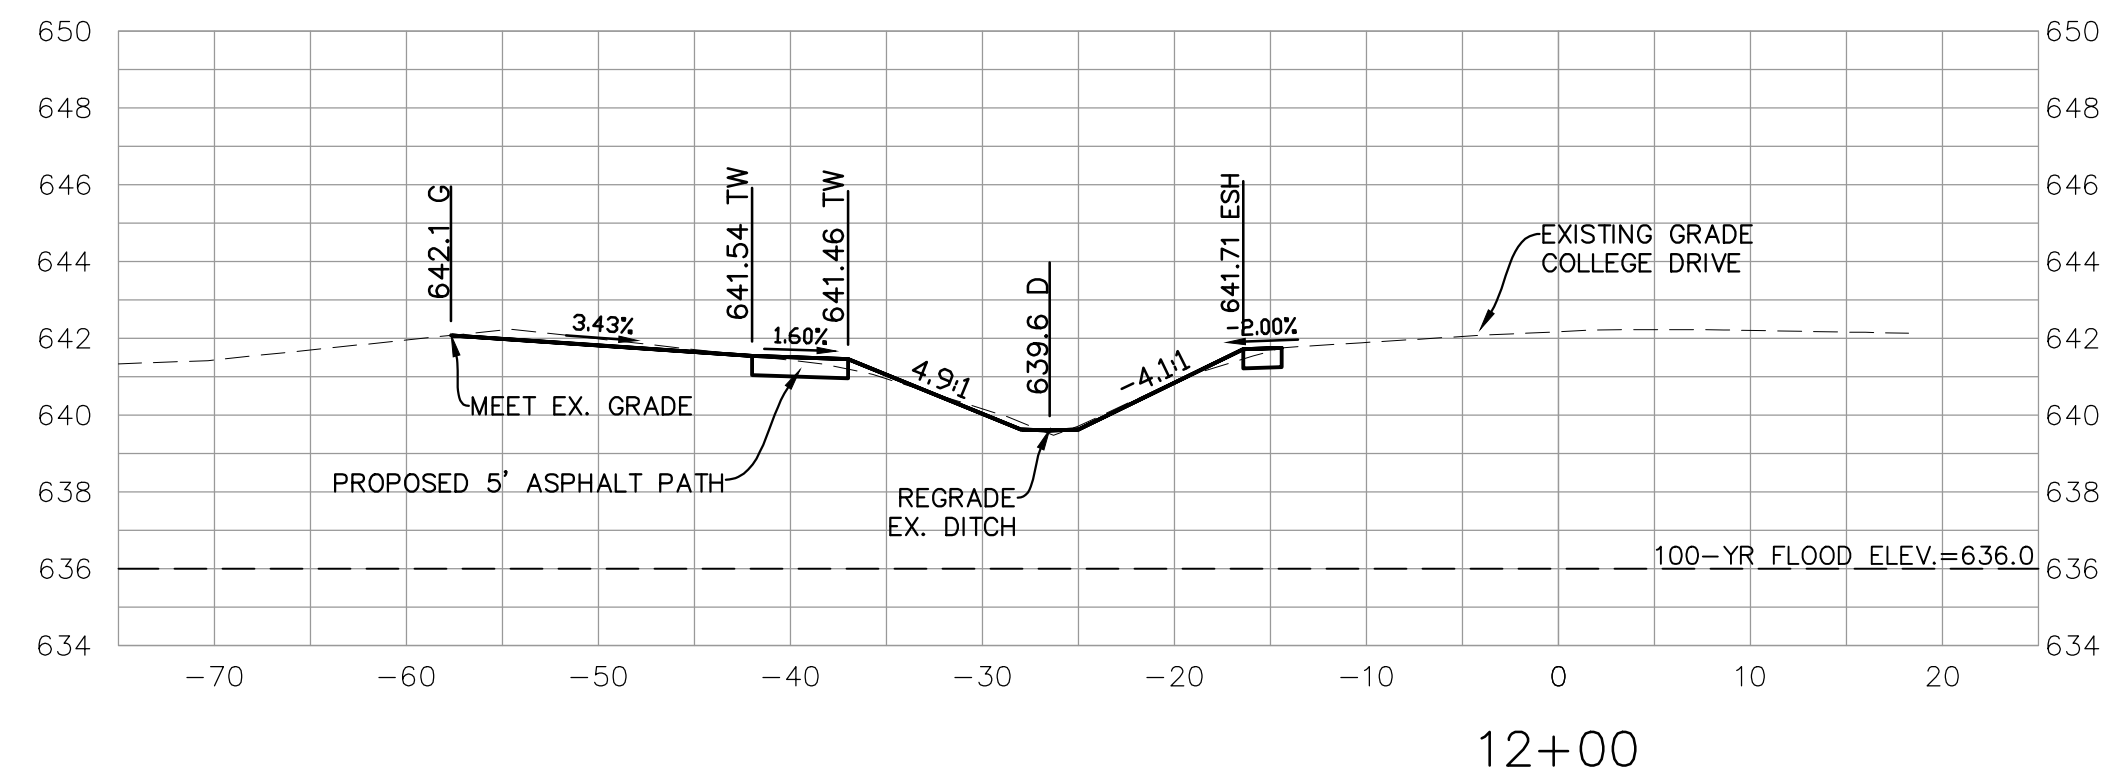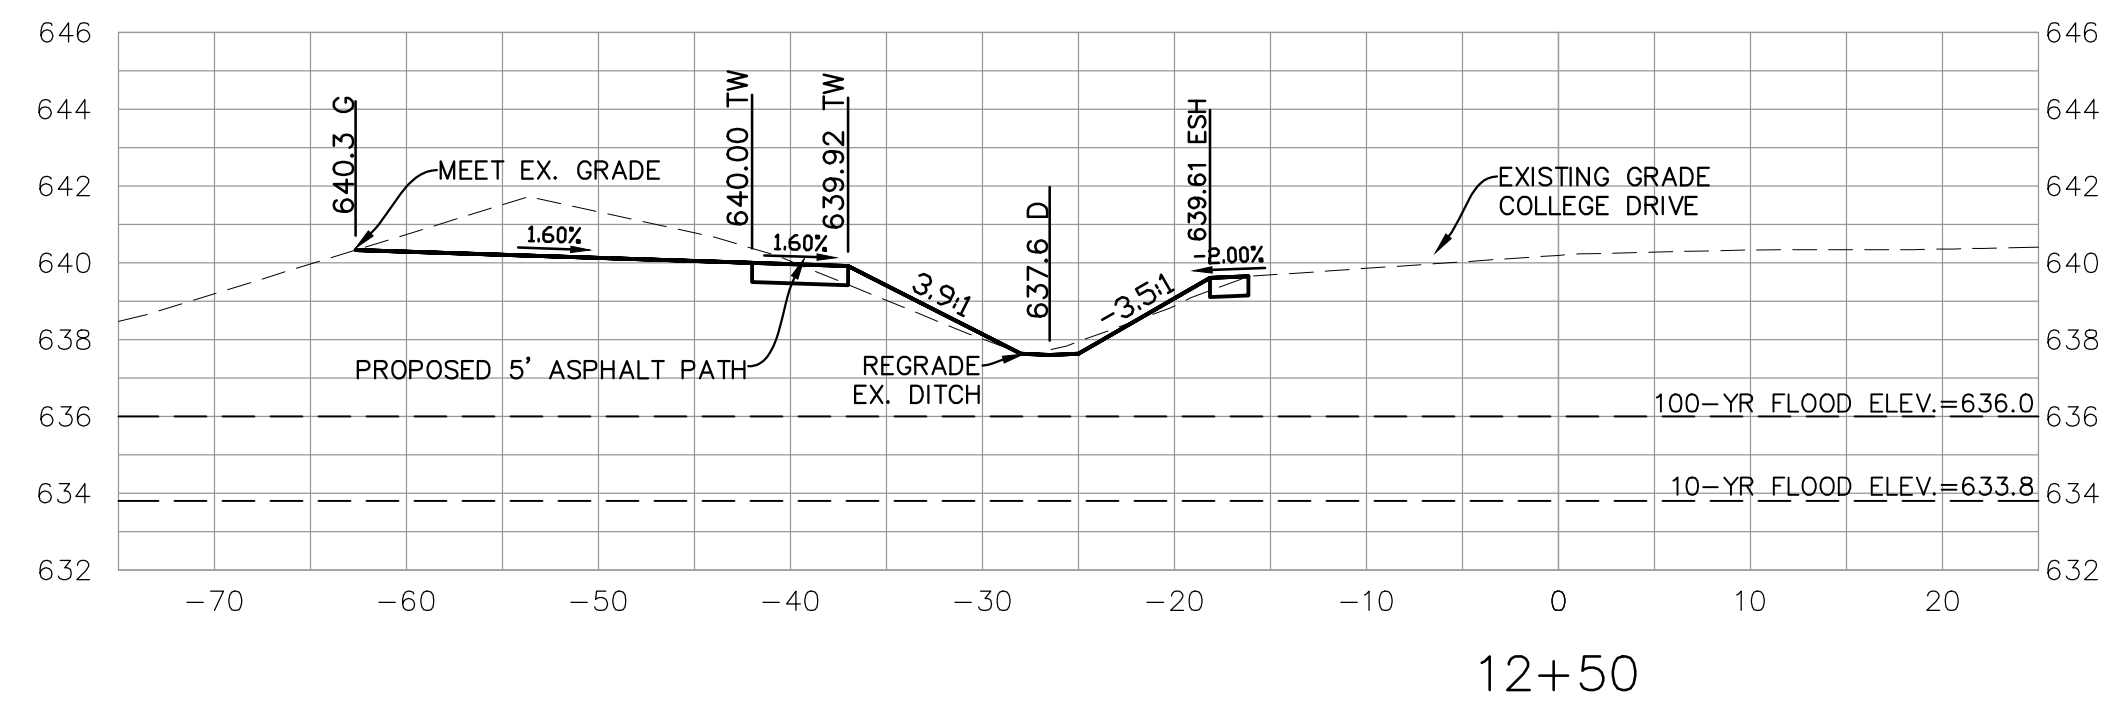

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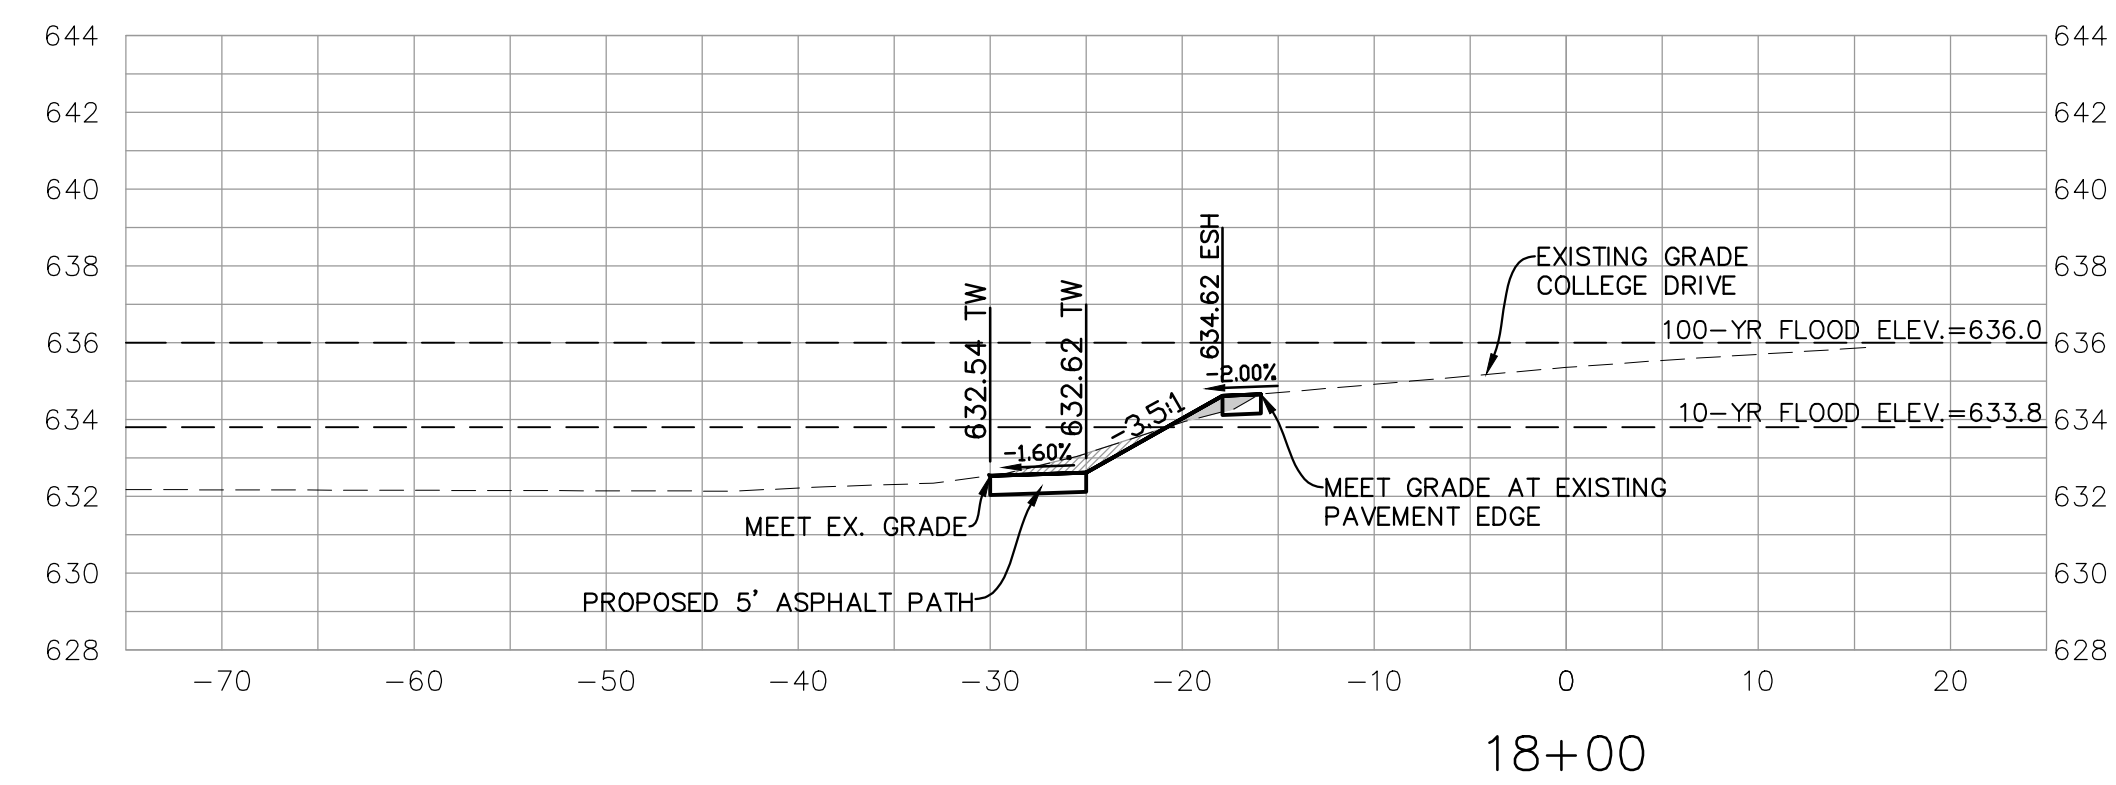
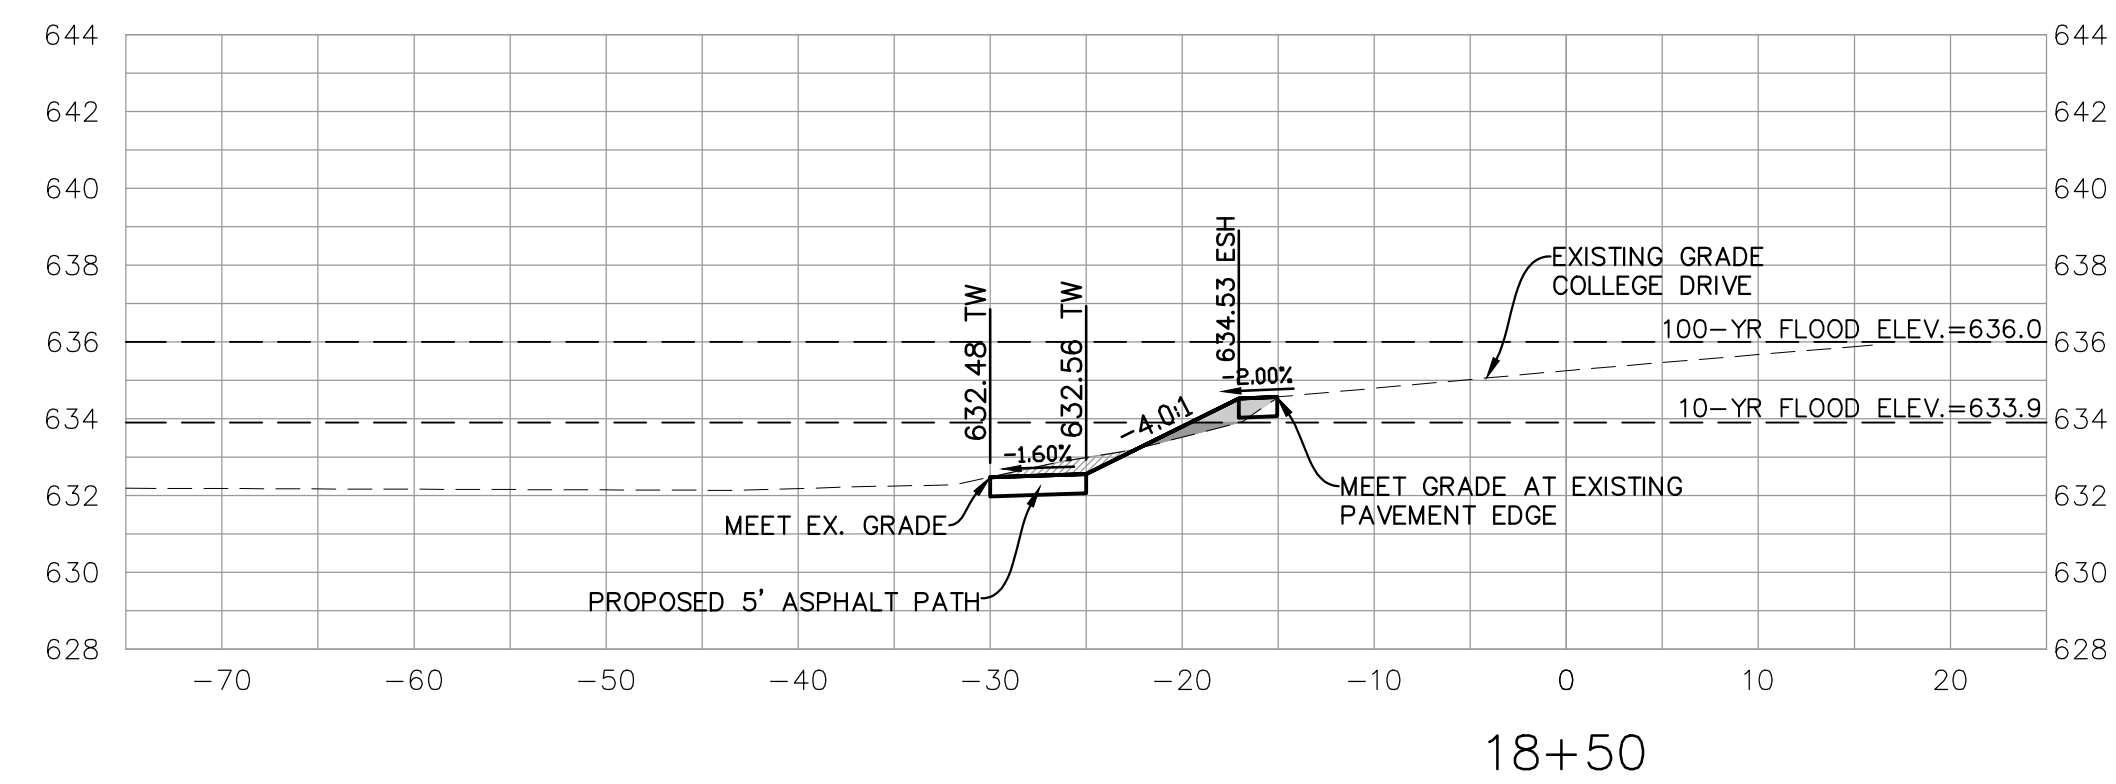
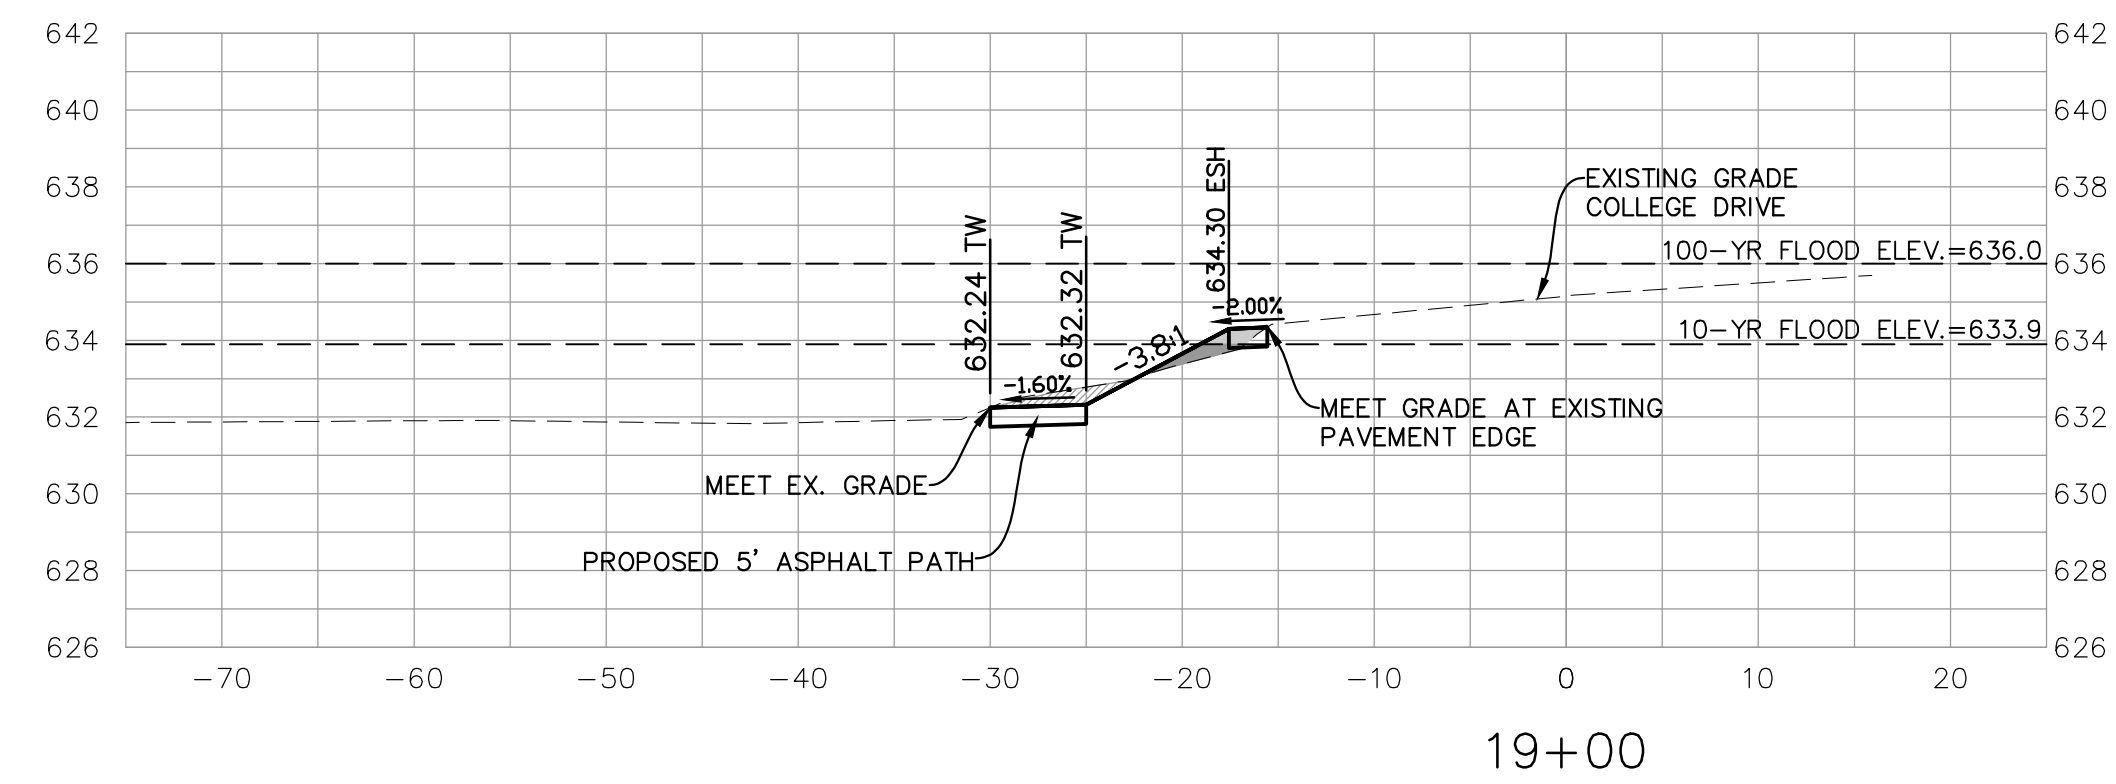
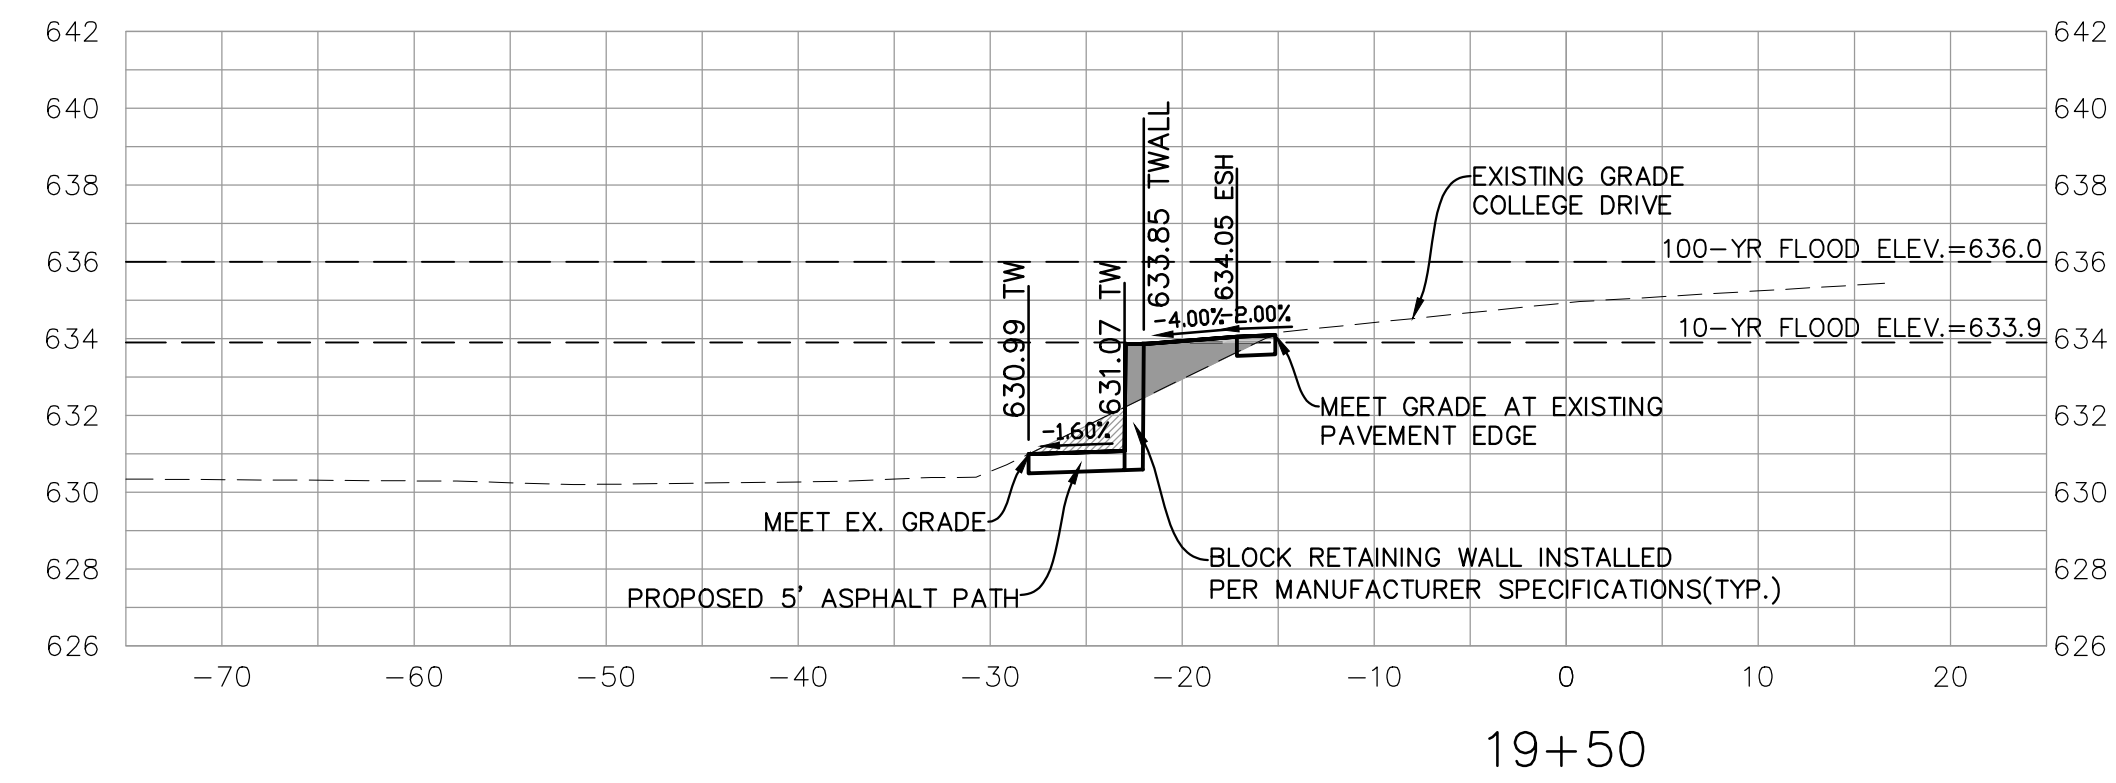
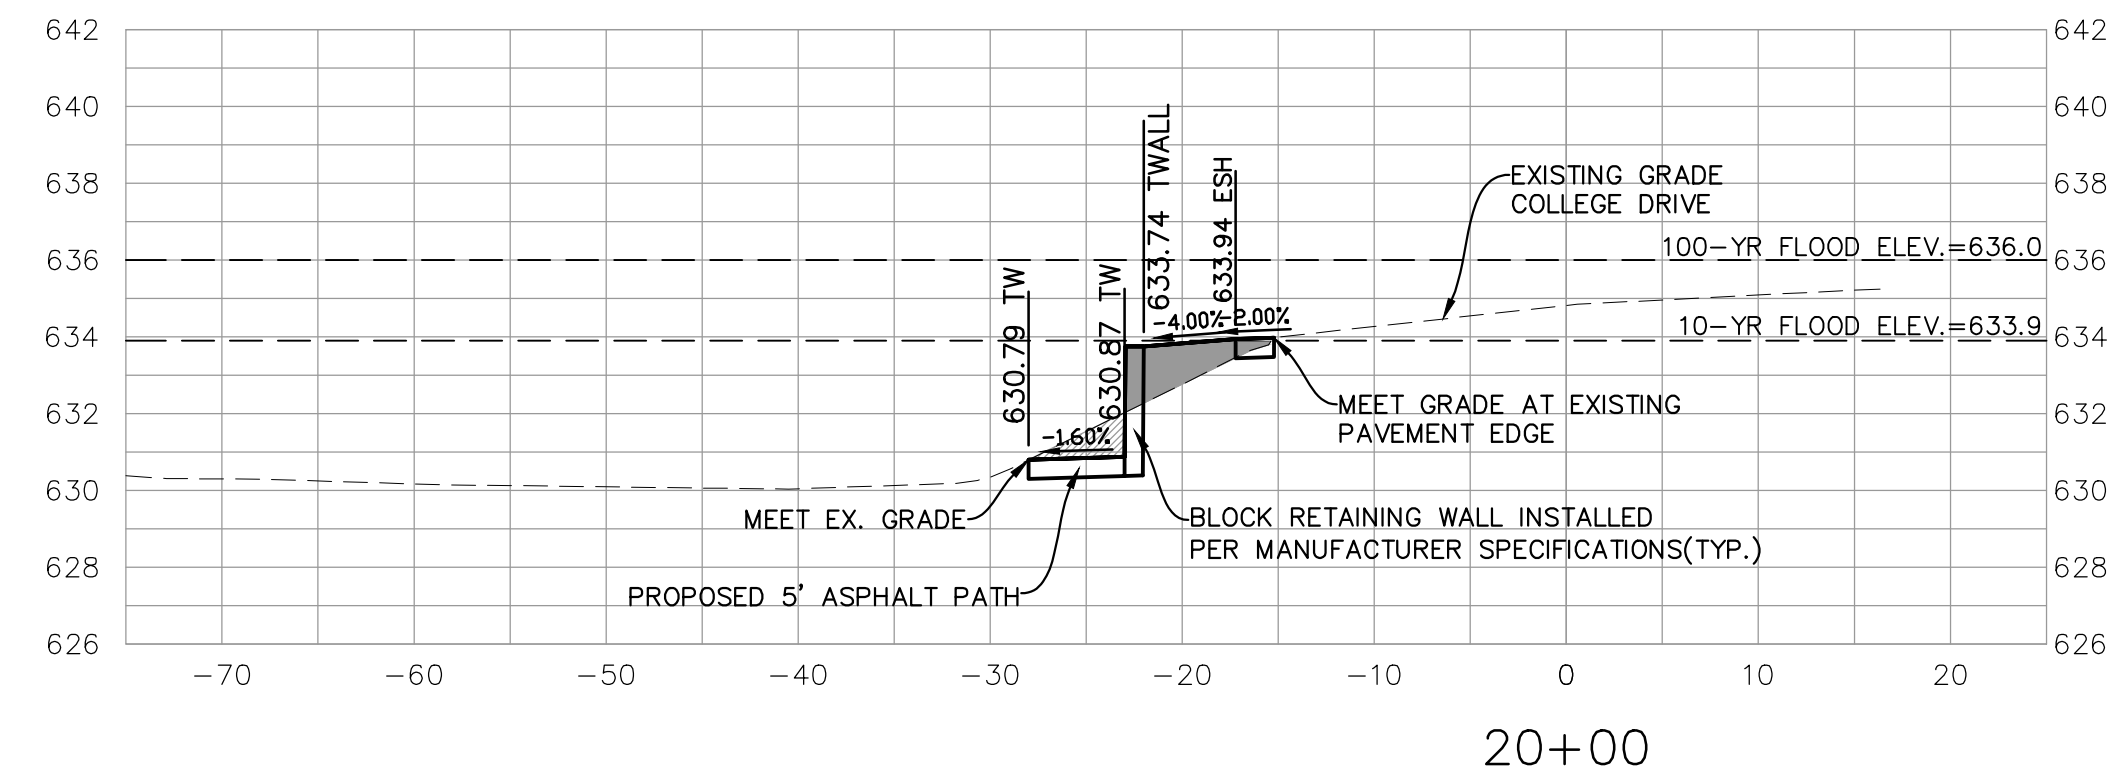
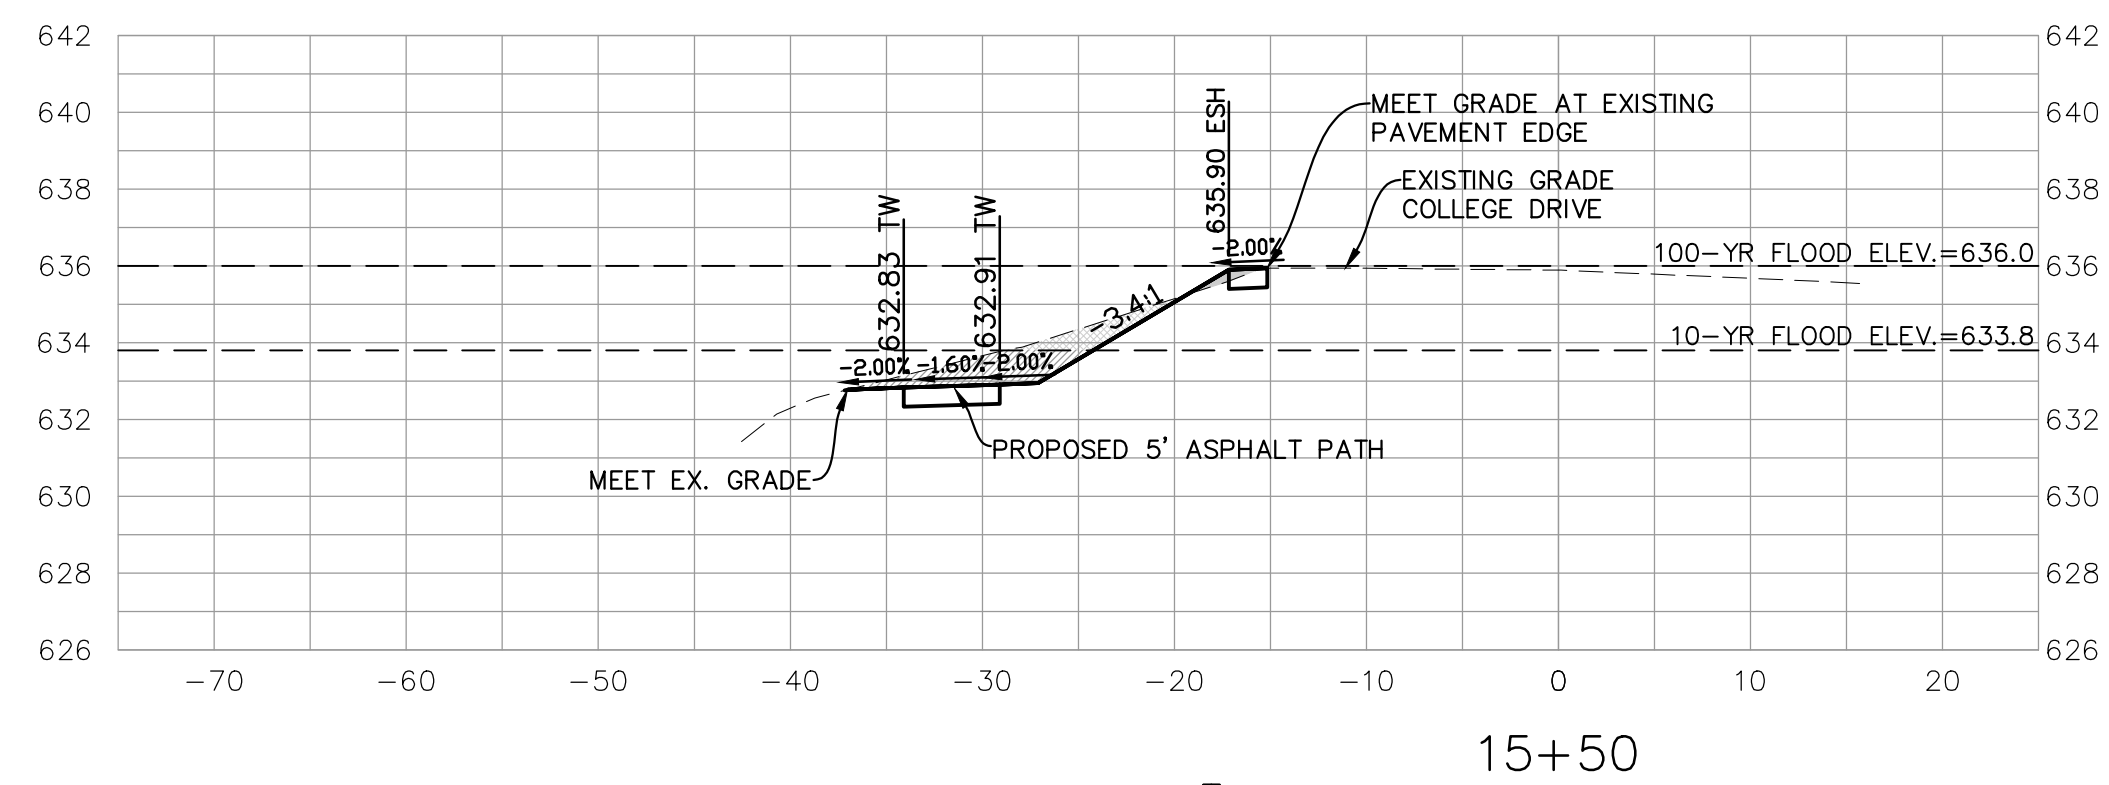
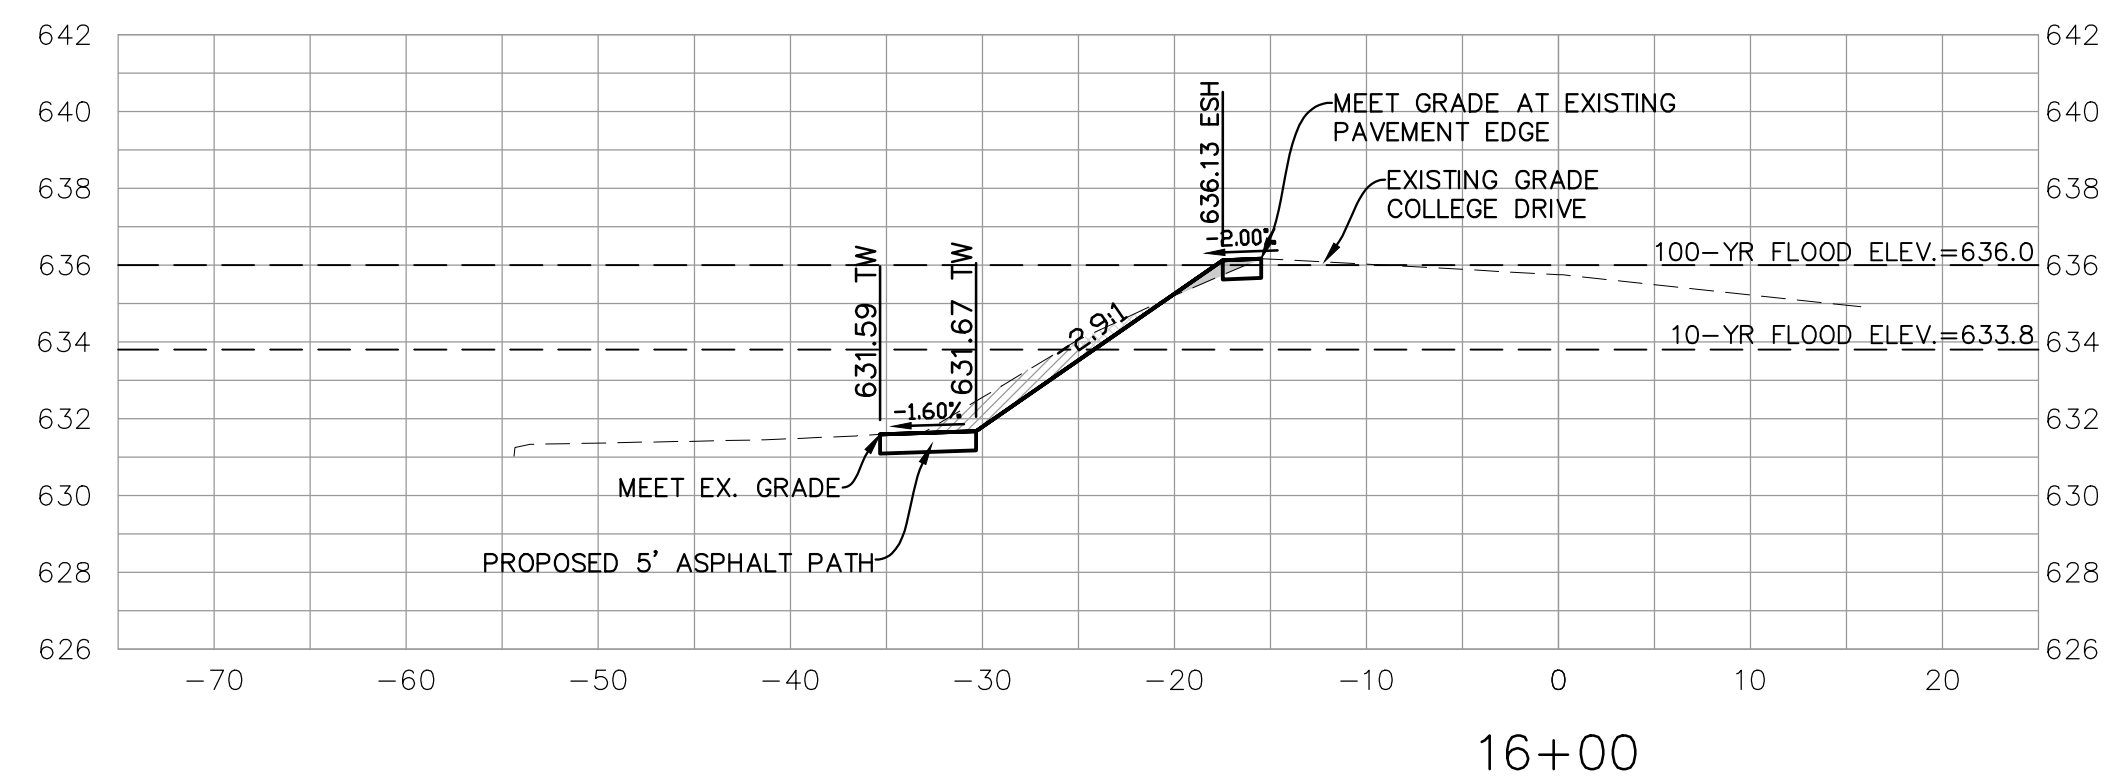
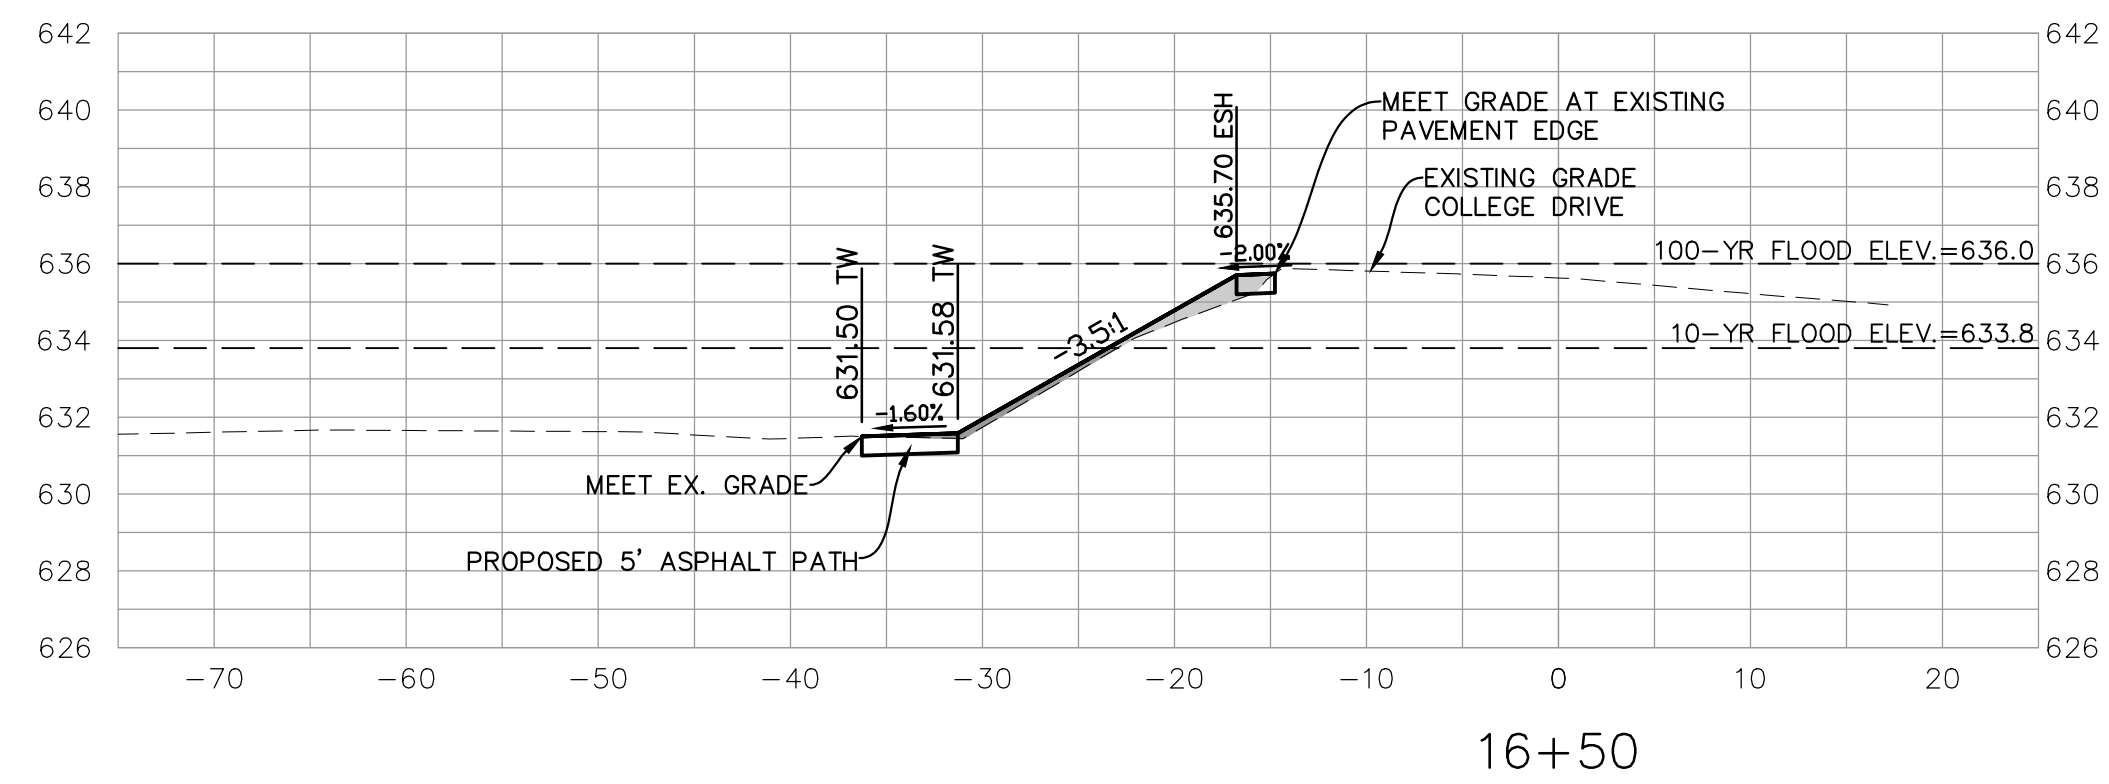
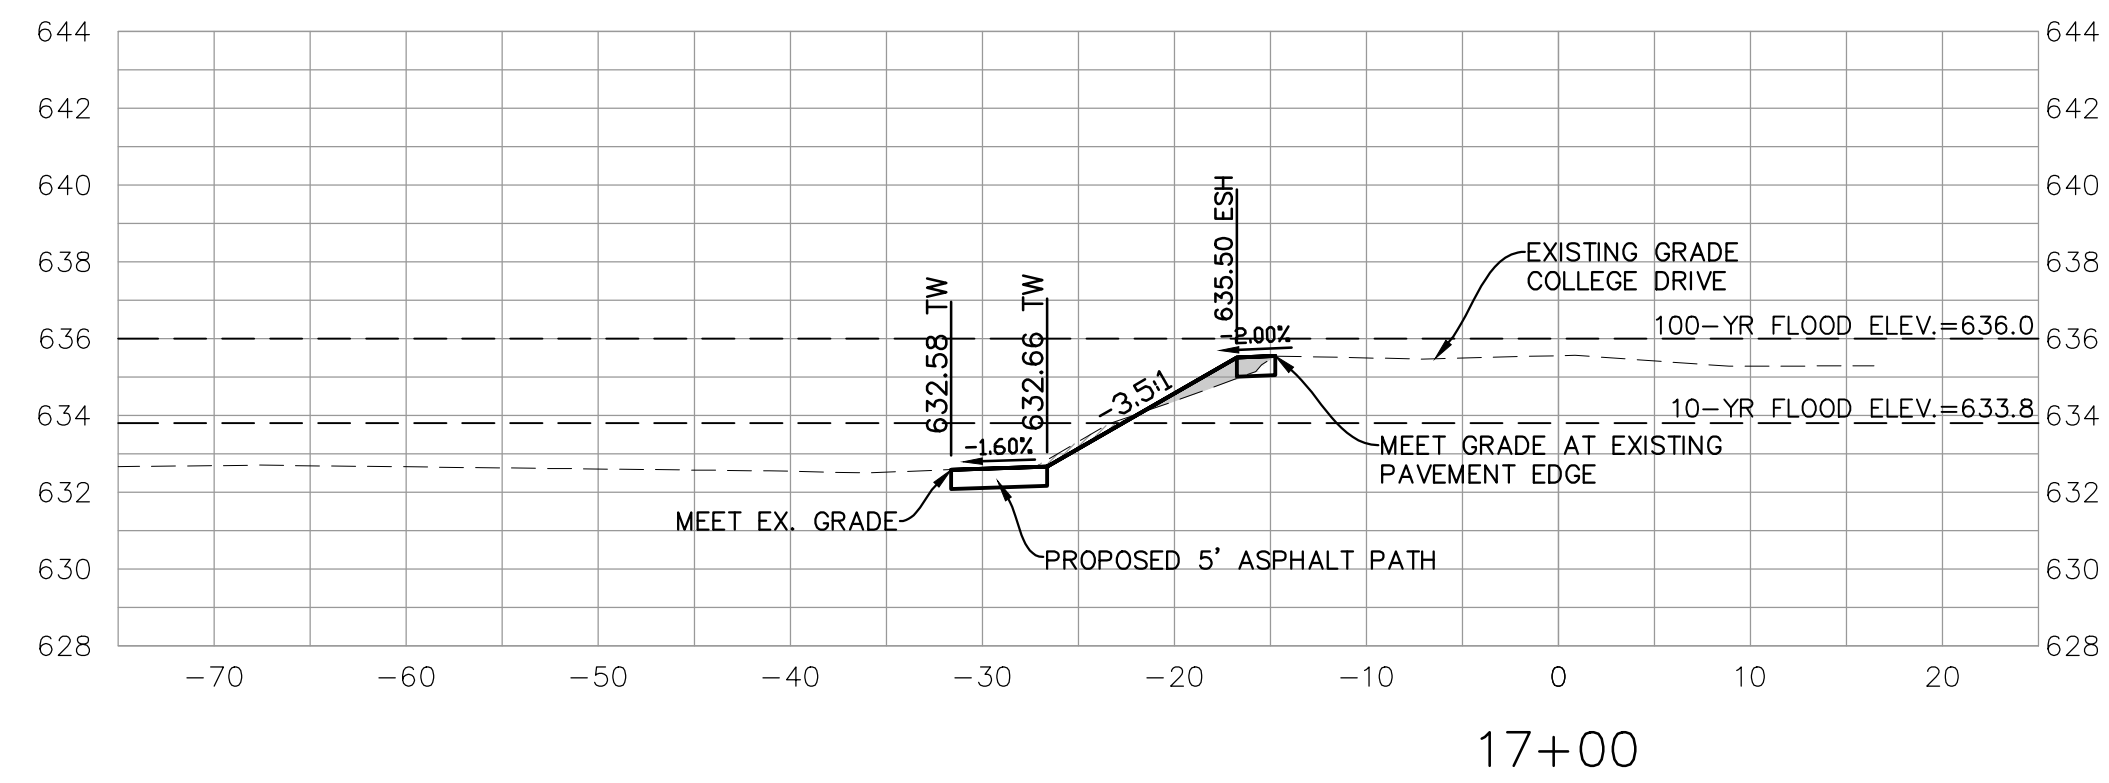
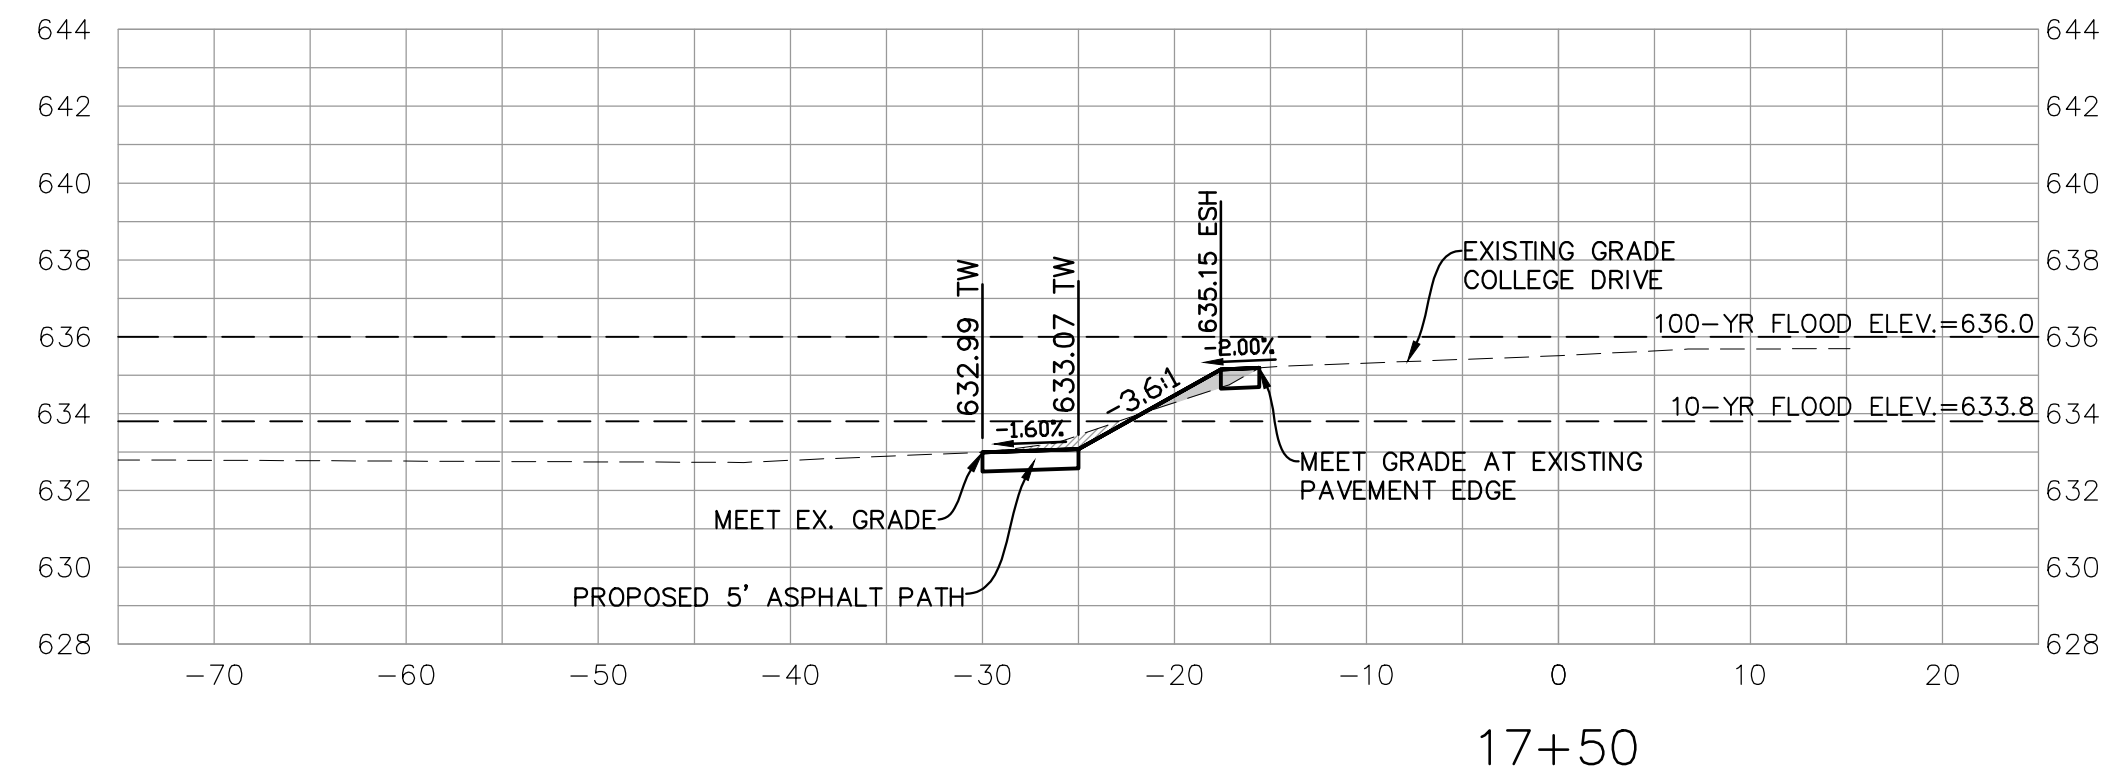
PEDESTRIAN AND BICYCLE PATHWAY
OAKTON COMMUNITY COLLEGE - DES PLAINES CAMPUS
CROSS-SECTIONS - STA.10+50 TO STA.15+00

PROJ. MGR:	DBM
PROJ. ASSOC.:	JWS
DRAWN BY:	AS
DATE:	05-04-21
SCALE:	1/4"=1'-0"
SHEET	21 OF 30
	OCCDP110

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ISSUED FOR BIDS

LEGEND	
	10-YR FILL
	10-YR CUT
	100-YR FILL
	100-YR CUT



December 16, 2022 - 13:07 Dwg Name: p:\occdp\10\Drawings\Final drawings\Plan_Sht\19-24-CROSS-SECTIONS.dwg Updated By: Whorn

DATE	REVISIONS
01-19-22	REVISED FOR METAL CABLE GUARDRAIL



PEDESTRIAN AND BICYCLE PATHWAY
OAKTON COMMUNITY COLLEGE - DES PLAINES CAMPUS
CROSS-SECTIONS - STA.15+50 TO STA.20+00

PROJ. MGR:	DBM
PROJ. ASSOC.:	JWS
DRAWN BY:	AS
DATE:	05-04-21
SCALE:	1/4"=1'-0"
SHEET	22 OF 30
	OCCDP110

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ISSUED FOR BID

MANHARD CONSULTING, LTD. STANDARD SPECIFICATIONS

GENERAL CONDITIONS
CONTRACTOR acknowledges and agrees that the use and reliance of these Plans and Specifications is sufficient consideration for CONTRACTOR'S covenants stated herein.
DEFINITION OF TERMS
a. "CLIENT" shall mean Oakton Community College...

INTENT OF THE PLANS AND SPECIFICATIONS
The intent of the PLANS and SPECIFICATIONS is to set forth certain requirements of performance, type of equipment and structures, and standards of materials and construction. They may also identify labor and materials, equipment and apparatus necessary for the proper execution of the work...

INTERPRETATION OF PLANS AND SPECIFICATIONS
a. The CLIENT and/or CONTRACTOR shall promptly report any errors or ambiguities in the PLANS and SPECIFICATIONS to the ENGINEER.
b. The ENGINEER will provide the CLIENT with such information as may be required to show revised or additional details of construction.

GOVERNING BODIES
All works herein proposed shall be completed in accordance with all requirements of any JURISDICTIONAL GOVERNMENTAL ENTITY, and all such pertinent laws, directives, ordinances and the like shall be considered to be a part of these SPECIFICATIONS.

LOCATION OF UNDERGROUND FACILITIES AND UTILITIES
When the PLANS and SPECIFICATIONS indicate information pertaining to the location of existing underground facilities and utilities (including but not limited to water mains, sanitary sewers, storm sewers, electric, telephone, gas and cable TV lines), such information represents only the opinion of the ENGINEER as to the approximate location and elevation of such facilities and utilities.

UNSUITABLE SOILS
The PLANS have been prepared by the ENGINEER based on the assumption that all soils on the project are suitable to support the proposed improvements shown. The CLIENT or CONTRACTOR shall immediately notify the ENGINEER if he discovers or encounters an obstruction that prevents the installation of the improvement according to the line and grades shown on the PLANS.

PROTECTION OF TREES
All trees that are not to be removed shall be protected from damage. Trees shall not be removed unless requested to do so in writing by the CLIENT.
NOTIFICATION OF OWNERS OF FACILITIES AND UTILITIES
The CONTRACTOR shall notify all applicable Jurisdictional Governmental Entities or utility companies, i.e., water, sewer, electric, telephone, gas and cable TV prior to beginning any construction so that said entity or company can establish the location and elevation of underground pipes, conduits or cables adjoining or crossing proposed construction.

TRAFFIC CONTROL
The CONTRACTOR shall provide when required by any JURISDICTIONAL GOVERNMENTAL ENTITY, all signs, equipment, and personnel necessary to provide for safe and efficient traffic flow in all areas where the work will interrupt, interfere or cause a change in any form, the conditions of traffic flow that existed prior to the commencement of any portions of the work.

WORK AREA
The CONTRACTOR, his agents and employees and their employees and all equipment, machinery and vehicles shall confine their work within the boundaries of the project or work area specified by the Client. The CONTRACTOR shall be solely liable for damage caused by him or his agents and employees and their equipment, machinery and vehicles on adjacent property or areas outside designated work areas.

UTILITY POLES
It shall be the responsibility of the CONTRACTOR to arrange for the relocation or bracing of existing utility poles that may be within the working limits of this contract. It is expressly understood that all work and costs connected with the maintenance of these utility poles, their temporary relocations, etc., shall be the responsibility of the CLIENT or the CONTRACTOR.

RESTORATION
It is the intent of these SPECIFICATIONS that clean-up and final restoration shall be performed immediately upon completion of each phase of the work, both inside and outside the Project, or when so directed by the CLIENT so that these areas will be restored as nearly as possible to their original condition or better, and shall include but not be limited to, restoration of maintained lawns and rights-of-way, roadways, driveways, sidewalks, ditches, bushes, hedges, trees, shrubs, fences, mailboxes, sewers, drain tiles, water mains, etc.

ROAD CLEANING
The CONTRACTOR shall maintain roadways adjoining the project site free from mud and debris at all times. If mud and/or debris is carried onto the roadways from vehicles entering onto the highway from either the CONTRACTOR'S trucks, his employees' vehicles, or his material suppliers, the CONTRACTOR shall immediately remove said mud and/or debris.

SAFETY AND PROTECTION
The CONTRACTOR shall be solely and completely responsible for the conditions of the job site, including safety of all persons and property during performance of the work. This requirement shall apply continuously and not be limited to normal working hours. The CONTRACTOR shall comply with all applicable Laws and Regulations relating to the safety of persons or property, or to the protection of persons or property from damage, injury, or loss; and shall erect and maintain all necessary safeguards for such safety and protection.

HOLD HARMLESS
To the fullest extent permitted by law, any CONTRACTOR, material supplier or other entity by use of these plans and specifications hereby waives any right of contribution and agrees to indemnify, defend, save and hold harmless the CLIENT and ENGINEER and its agents, employees and consultants from and against all manner of claims, causes, causes of action, damages, losses and expenses, including but not limited to, attorneys' fees arising out of, resulting from or in connection with the performance of any work, pursuant to and with respect to these plans and specifications.

INSURANCE
Any party using or relying on these plans, including any contractor, material supplier, or other entity shall obtain, prior to commencing any work) general public liability insurance insuring against all damages and claims for any bodily injuries, death or property damage arising out of any work, including the construction work provided for in these plans, and shall name the CLIENT and ENGINEER and its consultants, agents and representatives as additional insureds under such insurance policy, provided that any party using or relying on these plans having obligations to maintain specific insurance by reason of any agreement with CLIENT or any CONTRACTOR or ENGINEER shall provide evidence and certificates of insurance as required by such contract or agreement.

THIRD PARTY BENEFICIARY
Manhard Consulting, Ltd., the ENGINEER, is intended to be a third party beneficiary of this willing agreement and requirement.
Note: These Specifications are for Northern Illinois.

DETAILED SPECIFICATIONS

* I. DEMOLITION
The CONTRACTOR shall coordinate with respective utility companies prior to the removal and/or relocation of utilities. The CONTRACTOR shall coordinate with the utility company concerning portions of work which may be performed by the Utility Company's forces and any fees which are to be paid to the utility company for their services. The CONTRACTOR is responsible for paying for all fees and charges.

SHOULD REMOVAL AND RELOCATION ACTIVITIES DAMAGE FEATURES INDICATED TO REMAIN, THE CONTRACTOR SHALL PROVIDE NEW MATERIALS/STRUCTURES IN ACCORDANCE WITH THE CONTRACT DOCUMENTS. EXCEPT FOR MATERIALS DESIGNED TO BE RELOCATED ON THIS PLAN, ALL OTHER CONSTRUCTION MATERIALS SHALL BE NEW.
Prior to demolition occurring, all erosion control devices are to be installed.
All utility lines and conduits located under drives, on-site roads, parking lots or sidewalks shall be filled with a flowable backfill and end plugged. All existing structures shall be removed. All existing utility lines located under landscape areas shall be left in place and plugged at all structures.

incurred on any of the surrounding pavement, etc. the CONTRACTOR shall be responsible for ITS removal and repair.
Any existing wells encountered shall be exposed and sealed 3' below proposed finish grade by the CONTRACTOR in accordance with Section 920.120 (latest edition) of the Illinois Water Well Construction Code, Department of Public Health, and all applicable local rules and regulations. CONTRACTOR is responsible for obtaining all permits required by JURISDICTIONAL GOVERNMENTAL ENTITIES for abandoning existing wells.
Any existing septic tanks and grease traps encountered shall have all liquids and solids removed and disposed of by a licensed commercial hauler in accordance with JURISDICTIONAL GOVERNING ENTITY regulations, and the tank and grease traps shall then be filled with suitable materials or removed from the site and disposed of by the CONTRACTOR.
VOIDS left by any item removed under any proposed building, pavement, walk, etc. or within 24' thereof shall be filled and compacted with suitable materials by the CONTRACTOR.
CONTRACTOR shall develop and implement a daily program of dust control and shall submit and obtain JURISDICTIONAL GOVERNING ENTITY approval of dust control procedures prior to demolition of any structures. Modification of dust control procedures shall be performed by the CONTRACTOR to the satisfaction of the JURISDICTIONAL GOVERNING ENTITY as requested.

II. EARTHWORK STANDARDS
This work shall be completed in conformance with the applicable sections of the Standard Specifications for Road and Bridge Construction, Department of Transportation, State of Illinois, latest edition except as modified below.

SOIL BORING DATA
Copies of results of soil boring and reports, if any borings were taken by the CLIENT in the vicinity of the proposed construction site, should be made available to the CLIENT by the CONTRACTOR. These borings are presented for whatever purpose the CONTRACTOR chooses to make of them. The ENGINEER makes no representation or warranty regarding the number, location, spacing or depth of borings listed, nor of the accuracy or reliability of the information given in the results thereof.

EARTHWORK CALCULATIONS AND CROSS SECTIONS
The CONTRACTOR understands that any earthwork calculations, quantities or cross sections that have been furnished by the ENGINEER are for information only and are provided without any guarantee by the CLIENT or ENGINEER whatsoever as to their sufficiency or accuracy. CONTRACTOR warrants that he has performed his own subsurface investigations as necessary and his own calculations and cross sections to determine site soil conditions and earthwork volumes. The ENGINEER makes no representation or guarantee regarding earthwork quantities or that the earthwork for this project will balance due to the varying field conditions, changing soil types, allowable construction tolerances and construction methods that are beyond the control of the ENGINEER.

TOPSOIL STRIPPING
Upon completion of demolition, clearing, grubbing and tree removal, all topsoil shall be stripped from under all buildings and pavements areas, and other areas necessary to complete the work. Topsoil stripped shall be placed in stockpiles in locations as designated by the CLIENT.

TOPSOIL RESPREAD
Upon completion of roadway and/or parking lot improvements and installation of underground utilities a minimum of six inches (6") of topsoil shall be respread over all unpaired areas which have been disturbed by earthwork construction, except building pads and other designated areas, which shall be kept free from topsoil.

SEEDING
Upon completion of topsoil respread, the CONTRACTOR shall install seed to all areas designated on the plans or as designated on the landscape drawings and specifications provided by the CLIENT.

SODDING
Upon completion of topsoil respread, the CONTRACTOR shall install sod to all areas designated on the plans or as designated on the landscape drawings and specifications provided by the CLIENT.

* EXCAVATION AND EMBANKMENT
Upon completion of topsoil stripping, all excavation and embankments shall be completed as shown on the PLANS. All suitable excavated materials shall be hauled, placed (moisture conditioned if necessary) and compacted in the embankment areas. The CONTRACTOR shall include all dewatering, temporary ditching and culverts necessary to complete the excavation and embankment.

The CONTRACTOR shall notify the CLIENT if proper compaction cannot be obtained so that the CLIENT may determine what remedial measures may be needed.
A soils testing firm employed by the CLIENT shall determine which soils are unsuitable. Materials in their natural state being defined as unsuitable that would be suitable material if moisture conditioned, shall be conditioned by the CONTRACTOR and used as suitable embankment material or hauled from the site.

Table with 5 columns: Percent Compaction, Type Material, Standard, Pavement & Floor Slabs, and Gross Areas. Rows include Sandy Soils, Clayey Soils, etc.

CLEANING UP
The CONTRACTOR shall at all times keep the premises free from accumulations of waste material or rubbish caused by his employees or work, and at the completion of the work he shall remove all his rubbish, tools, scaffolding and surplus materials and shall leave his work "broom clean" or its equivalent, unless more exactly specified.

EROSION CONTROL
Suitable erosion control practices shall be maintained by the CONTRACTOR in accordance with Illinois Urban Manual and all applicable Soil Erosion and Sedimentation Control ordinances and the PLANS.
UNDERCUTTING DURING EARTHWORK
If the subgrade cannot be dried adequately by dicing as outlined above for placement of material to planned grades and if the CLIENT determines that the subgrade does not meet the standards set forth above, the CLIENT may require undercutting.

MISCELLANEOUS CONTRACT ITEMS
The following items may be required at the CLIENT'S option, as indicated on the PLANS or as required by the JURISDICTIONAL GOVERNING ENTITY:
(1) GEOTEXTILE FABRIC
Geotextile fabric or approved equal shall be provided in areas as designated by the CLIENT, as indicated on the PLANS or as required by the JURISDICTIONAL GOVERNING ENTITY where proper compaction of embankments over existing soft soils is not possible.

(2) EROSION CONTROL BLANKET
Erosion control blanket or approved equal shall be provided in areas as designated by the CLIENT, as indicated on the PLANS or as required by the JURISDICTIONAL GOVERNING ENTITY for the stabilization of disturbed areas. Erosion control blanket shall meet the material specifications of and shall be installed in accordance with the above standards, the Illinois Urban Manual and/or the details shown on the PLANS.

III. UNDERGROUND IMPROVEMENTS

A. GENERAL STANDARDS
All underground improvements shall be constructed and tested in accordance with the Standard Specifications for Water and Sewer Construction in Illinois and Standard Specifications for Road and Bridge Construction, Department of Transportation, State of Illinois, latest edition. In the event of conflicting guidelines, the more restrictive shall govern.

SELECTED GRANULAR BACKFILL
Selected Granular Backfill shall be required for all sewer and water main trenches lying under existing or proposed streets, driveways, parking lots and within 24' thereof, and where noted on PLANS. All material placed in such trenches shall be in accordance with the above standards.
MANHOLES, CATCH BASIN, INLETS & VALVE VAULTS
All Manholes, Catch Basins, Inlets, and Valve Vaults shall be constructed of reinforced precast concrete ring construction with tongue and groove joints in conformance with the latest revision of ASTM designation C-478. All joints between sections and frames (except sanitary manholes, see Section IIB Manholes, below) shall be sealed with mastic type bituminous jointing compound. CONTRACTOR shall remove all excess mastic on inside of structure and butter joints with mortar. Manholes are to have offset cones except that no cone shall be used on storm manholes 6'-0" deep or less in which case a reinforced concrete flat top section shall be used, and Valve Vaults shall have conentric cones. Only concrete adjustment rings will be permitted where necessary and shall be limited to two adjustment rings totaling not more than 8" in height. All manholes and catch basin steps shall be copolymer polypropylene with continuous 3/8" steel reinforcement as manufactured by MA Industries, or approved equal.

* AUGER/BORING AND CASING - INTENTIONALLY OMITTED
* AUGER (OPEN BORE) - INTENTIONALLY OMITTED
HORIZONTAL AND VERTICAL SEPARATION OF WATER AND SEWER MAINS
Horizontal and vertical separation of water and sewer mains shall be in accordance with Standard Specifications for Water and Sewer Construction in Illinois Section 41-2.01A and 41-2.01B and Standard Drawing 18, 19, 20, 21, 22, 23 and 24.

STRUCTURE ADJUSTMENTS
Structures shall be adjusted to the finished grade as shown on PLANS.
* B. SANITARY SEWERS AND APPURTENANCES - INTENTIONALLY OMITTED

* C. WATER MAINS AND APPURTENANCES - INTENTIONALLY OMITTED

D. STORM SEWERS AND APPURTENANCES

- * STORM SEWER PIPE
Storm sewer pipe shall conform to the following:
(1) Reinforced concrete pipe minimum Class IV in conformance with the latest revision of ASTM designation C76 with C361 or C443 flexible gasket joints, except that bituminous mastic joints may be used in grass areas.
(2) Polyvinyl Chloride (PVC) Pipe: ASTM D3034 (4-inch thru 15-inch) or ASTM F679 (18-inch thru 36-inch), rated SDR 35, continually marked with manufacturer's name, pipe size, cell classification, SDR rating. Joints shall be flexible elastomeric seals conforming to ASTM D3312.
(3) Ductile Iron Pipe (DIP) shall conform to ANSI/AWWA C151/21.5, Class 50 cement lined with push on type joints conforming to ANSI/AWWA C111/A21.11.

Manholes, Inlets & Catch Basins shall be constructed in conformance with Section IIA Manholes, etc. above. The space between connecting pipes and the wall of the manhole shall be filled with mortar. Frames and lids shall be 16-inch or approved equal unless specified otherwise on the PLANS. All frames and grates shall be provided such that the flange fully covers the opening plus 2" of the structure as a minimum. Provide "Vane" Type frame & grate for all structures located in curb where gradient exceed 2.0%. Manholes shall include steps, frame & grate, bedding and trench backfill.
FLARED END SECTION
Flared end sections shall be pre-cast reinforced concrete flared end section with an end block cast separate as per the Illinois Department of Transportation Standard 542301 and shall be installed where shown on the PLANS. All flared end sections for storm sewers 12" in diameter and larger shall be installed with a grating per Standard 542311 and/or as detailed on the PLANS. Work shall include end block.
RIP RAP
Stone rip rap consisting of pieces of "A" quality stone 4" to 6" in diameter shall be furnished and installed in accordance with IDOT Specifications and shall be placed where shown on the plans, to a minimum thickness of 12" and a width as indicated on the plans. Broken concrete or concrete blocks will not be acceptable.

FOUNDATION, BEDDING AND HAUNCHING
Foundation, Bedding and Haunching shall be wet coarse aggregate or moist fine aggregate in accordance with the above standards and placed as shown on the detail.
UNDERDRAINS
Pipe underdrains shall be corrugated flexible plastic pipe conforming to AASHTO Designation M252 perforated corrugated polyethylene pipe (PE) with a smooth interior of the diameter indicated on the PLANS and wrapped in a soil filter fabric supplied and installed by the CONTRACTOR. Performors may be circular or slotted, but shall provide a minimum inlet area of 1.0 square inch per 2.0 linear feet of pipe. CONTRACTOR shall submit fabric and pipe catalogue Specifications for approval by the CLIENT. CONTRACTOR shall bed and backfill the underdrain in one of the following IDOT gradations of aggregate (CA-5, CA-7, CA-11, CA-14 or CA-15).

MISCELLANEOUS
(1) All existing field drainage tile or storm sewers encountered or damaged during construction shall either be restored to their original condition, properly rerouted and/or connected to the storm sewer system.
(2) Footing drains shall be connected to sump pumps or discharged directly into storm sewers. Footing drains or drainage tile shall not be connected to the sanitary sewer.

* CONNECTION FOR STORM SERVICE TO STORM MAIN - INTENTIONALLY OMITTED
IV. ROADWAY AND PARKING LOT IMPROVEMENTS STANDARDS
Work shall be completed in accordance with the applicable sections of the Standard Specifications for Road and Bridge Construction, Department of Transportation, State of Illinois, latest edition (hereinafter referred to as the "Standard Specifications") except as modified below and except that payment will be defined as detailed in the contract documents between the CLIENT and the CONTRACTOR. Supplementing the Standard Specifications shall be the applicable sections of the latest editions of the "Supplemental Specifications and Recurring Special Provisions", the "Manual on Uniform Traffic Control Devices for Streets and Highways" and the Illinois Supplement thereto, (hereinafter referred to collectively as the "MUTCD"). Any references to "ENGINEER" in the "Standard Specifications" shall be interpreted as the CLIENT or CLIENT'S Construction Representative.

AGGREGATE BASE COURSE TYPE 'B'
Aggregate Base Course Type B shall be limited to CA-6 or CA-10 gradation. Aggregate base courses shall be proof rolled as outlined below.
PROOF ROLL
The CONTRACTOR shall proof roll the subgrade with either a 2-axle truck loaded to 27,000 lbs. Or a 3-axle truck loaded to 45,000 lbs. or as specified by the JURISDICTIONAL GOVERNING ENTITY. The CLIENT and JURISDICTIONAL GOVERNING ENTITY shall observe and approve the proof rolling of the subgrade and the base course. Proof rolling tolerances shall be a maximum deflection of 1" for the subgrade and 1/2" for the base course. The above criteria is intended as a maximum deflection standard and that proof rolling of a majority of the area will have less deflection than specified above. In any case of deficiency, the subgrade and/or base course shall be repaired and retested before proceeding with the pavement construction.

PAVEMENT SUBGRADE MATERIAL shall not be removed, placed or disturbed after proof roll testing has been completed prior to the pavement construction. Additional testing will be required if the pavement subgrade is disturbed and/or material is removed from or placed on the pavement subgrade after proof rolling approval.
Trucks or heavy equipment shall not travel on any pavement subgrade after final testing prior to pavement construction.

* HOT-MIX ASPHALT BASE COURSE - INTENTIONALLY OMITTED
HOT-MIX ASPHALT BINDER AND SURFACE COURSE
HMA binder and surface courses, shall be constructed to the compacted thickness as shown on the PLANS. The base course shall be cleaned and primed in accordance with the JURISDICTIONAL GOVERNING ENTITY. The surface course shall be placed after the base and courses have gone through one winter season, or as directed by the CLIENT. Before applying the surface course, the binder course shall be thoroughly cleaned and primed in accordance with the JURISDICTIONAL GOVERNING ENTITY. Prior to the placement of the surface course, the JURISDICTIONAL GOVERNING ENTITY shall examine the completed pavement, including curb and gutter, and all failures shall be corrected by the CONTRACTOR.

CONCRETE PAVEMENTS
Concrete pavements shall be constructed in accordance with American Concrete Institute Standard AC3039R-08 and as shown on the PLANS. Slabs and driveway aprons shall be constructed with 6" x 6" - W1.4 x W1.4 welded wire fabric positioned on steel chair supports. Placing fabric during the concrete pouring operation will not be allowed. Sawsing of joints shall commence as soon as the concrete has cured and hardened sufficiently to permit sawing without excessive raveling, but no later than eight hours after the concrete has been placed. All joints shall be sawed to a depth equal to 1/3 of the pavement thickness before uncontrolled shrinkage cracking take place. If necessary, the sawing operation shall occur during the day or at night, regardless of weekends, holidays or weather conditions. The CONTRACTOR shall be aware of jurisdictional noise ordinances and holiday restrictions for scheduling purposes.

The CONTRACTOR is responsible to guard fresh concrete until it sets and hardens sufficiently to prevent people from writing, walking, riding bicycles or otherwise permanently marking, defacing or causing depressions of any type and in the concrete. Any concrete so marked will be removed and replaced by the CONTRACTOR at the CONTRACTOR'S expense.
The CONTRACTOR shall protect the pavement against all traffic, including that of their own employees or other workers, until test specimens have attained the specified strength.
SIDEWALKS
Concrete sidewalks shall be constructed to width and thickness as shown on the PLANS. Sidewalks shall be thickened to a minimum of 6" at all driveways. All sidewalks shall be IDOT Class 31 concrete, an aggregate base as shown on the detail. A 1/2" expansion joint shall be provided when meeting existing sidewalk.

CURB AND GUTTER
Curb and gutter shall be as per the detail shown on the PLANS, which shall include compacted aggregate base course under the curb and gutter. All contraction and expansion joints shall be constructed as per the detail.
CONCRETE CURB AND GUTTER REMOVAL AND REPLACEMENT
The CONTRACTOR shall saw cut and remove the existing concrete curb where shown on the PLANS and install a curb of similar cross section and pavement to that removed (or depressed curb and gutter if shown on the PLANS). Upon completion of the curb and gutter any voids between the existing pavement and the new curb shall be filled with concrete to within 2" of the final surface, which is to be filled with bituminous pavement. The area behind the curb shall be filled and compacted with embankment material within 6" of the top of the new curb. The CONTRACTOR shall then restore the remaining 6" to its original condition (i.e., sod, gravel, topsoil). Where proposed curb connects to an existing curb, the existing curb shall be saw cut and then two 18" long x 1/2" (18) dowel bars shall be drilled and installed 9" into the existing and proposed curb. Bars shall be installed in a location similar to the expansion joint in the curb.

FRAME ADJUSTMENTS
The road contractor shall be responsible for making final adjustments and the setting on a bituminous mastic jointing compound all castings located in the roadway, sidewalks, and parking areas prior to construction of any curbing, sidewalk, or final surface. Any structures that need to be lowered, or raised in excess of 4" shall be completed and the work backcharget against the underground contractor. This Contractor shall also be responsible for cleaning of all the above structures immediately upon completion of his phase of work. This work shall be incidental to the cost of the pavement.

PAVEMENT MARKING - PAINT
The CONTRACTOR shall furnish and apply painted marking lines, letters & symbols of the patterns, sizes and colors where shown on the PLANS. Paint pavement marking shall be applied in accordance with the IDOT Standard Specifications.
* PAVEMENT MARKING - THERMOPLASTIC - INTENTIONALLY OMITTED

QUALITY CONTROL
The CONTRACTOR shall provide all testing necessary to ensure improvements are in accordance with the project specifications and provide testing documentation that specifications were met.

V. PRODUCTS BENCHES
Product: Knight Bench, FSC 100% iPE hardwood slats, 8 foot, backed, surface mount bench by Forms + Surfaces.
1. Model: SBKN1-0968
2. As supplied by: Forms + Surfaces, contact Shawn Davison, territory manager, 1(800)451-0410, Shawn.Davison@forms-surfaces.com.






A. Mounting: surface mount to concrete pad per manufacturer's recommendation with stainless steel, tamper-proof hardware.
B. Quantity: two (2)
C. Assemble and install in locations shown on plan.

Table with columns: DRAWN BY, REVISIONS, DATE, and a grid for revision tracking.

Manhard Consulting Ltd logo and contact information including address, phone, and website.

Project information including drawing title (PEDESTRIAN AND BICYCLE PATHWAY), project name (OAKTON COMMUNITY COLLEGE - DES PLAINES CAMPUS), and drawing number (27 OF 30).

ALL IDOT STANDARD AND DETAILS FOR CONSTRUCTION SHALL TAKE PRECEDENCE FOR WORK WITHIN THE STATE RIGHT OF WAY
SHOULD A CONFLICT ARISE BETWEEN MANHARD DETAILS AND THE VILLAGE OR IDOT DETAILS, THE VILLAGE OR IDOT DETAILS SHALL TAKE PRECEDENCE.

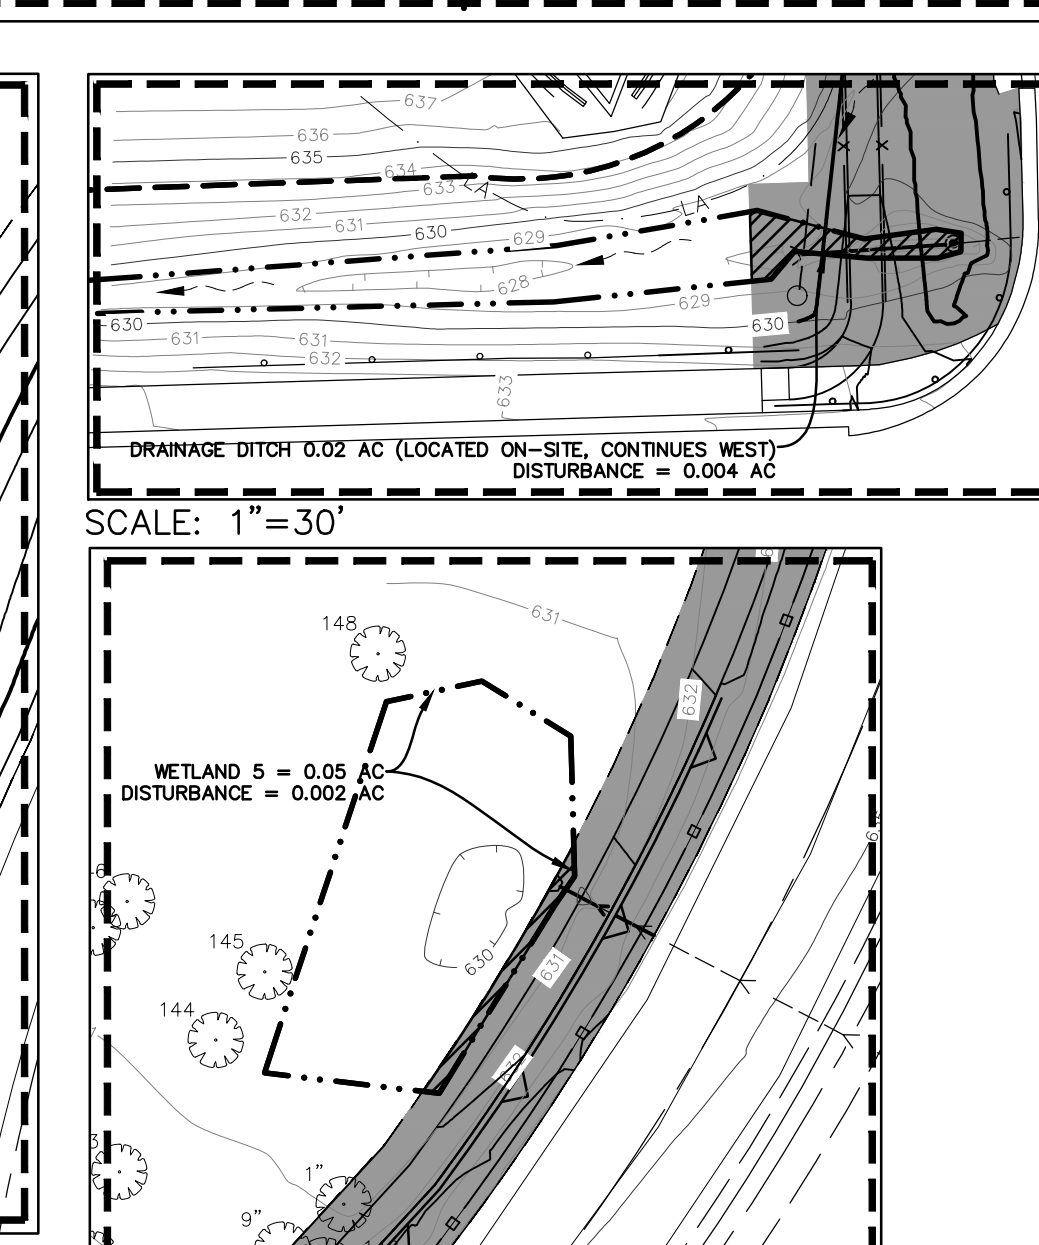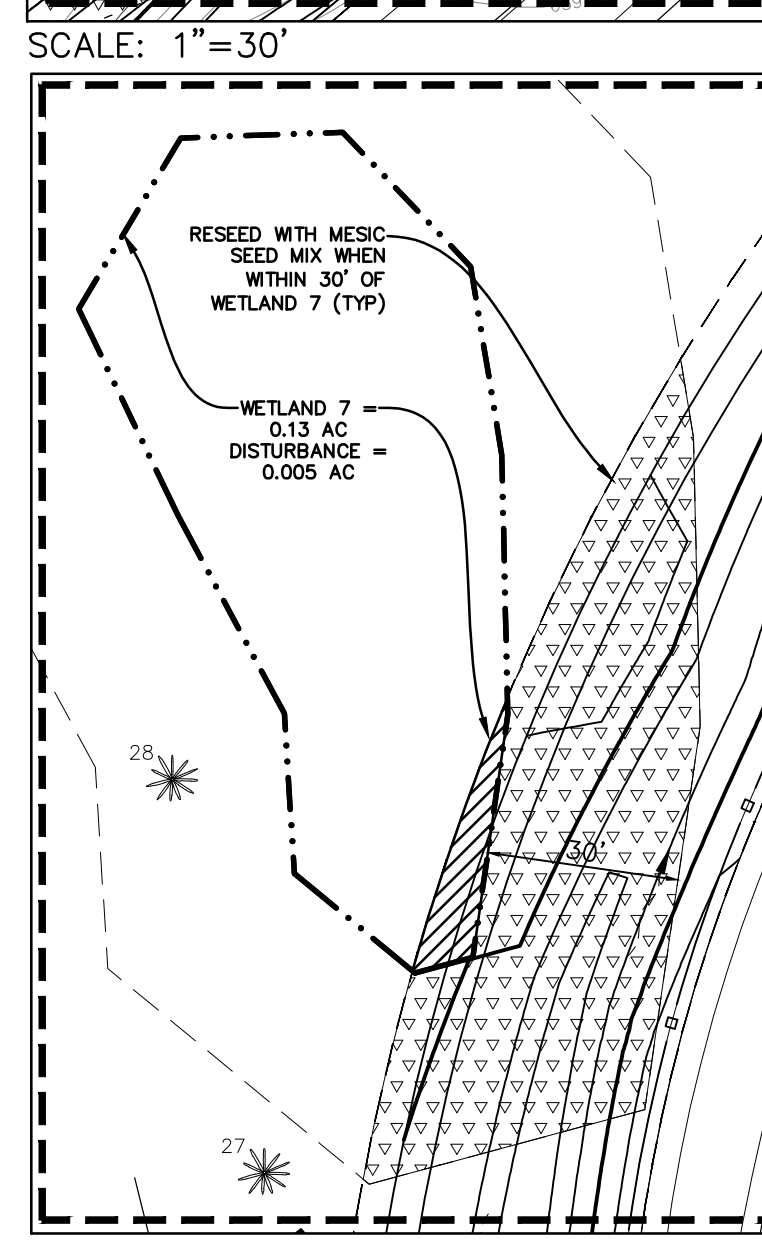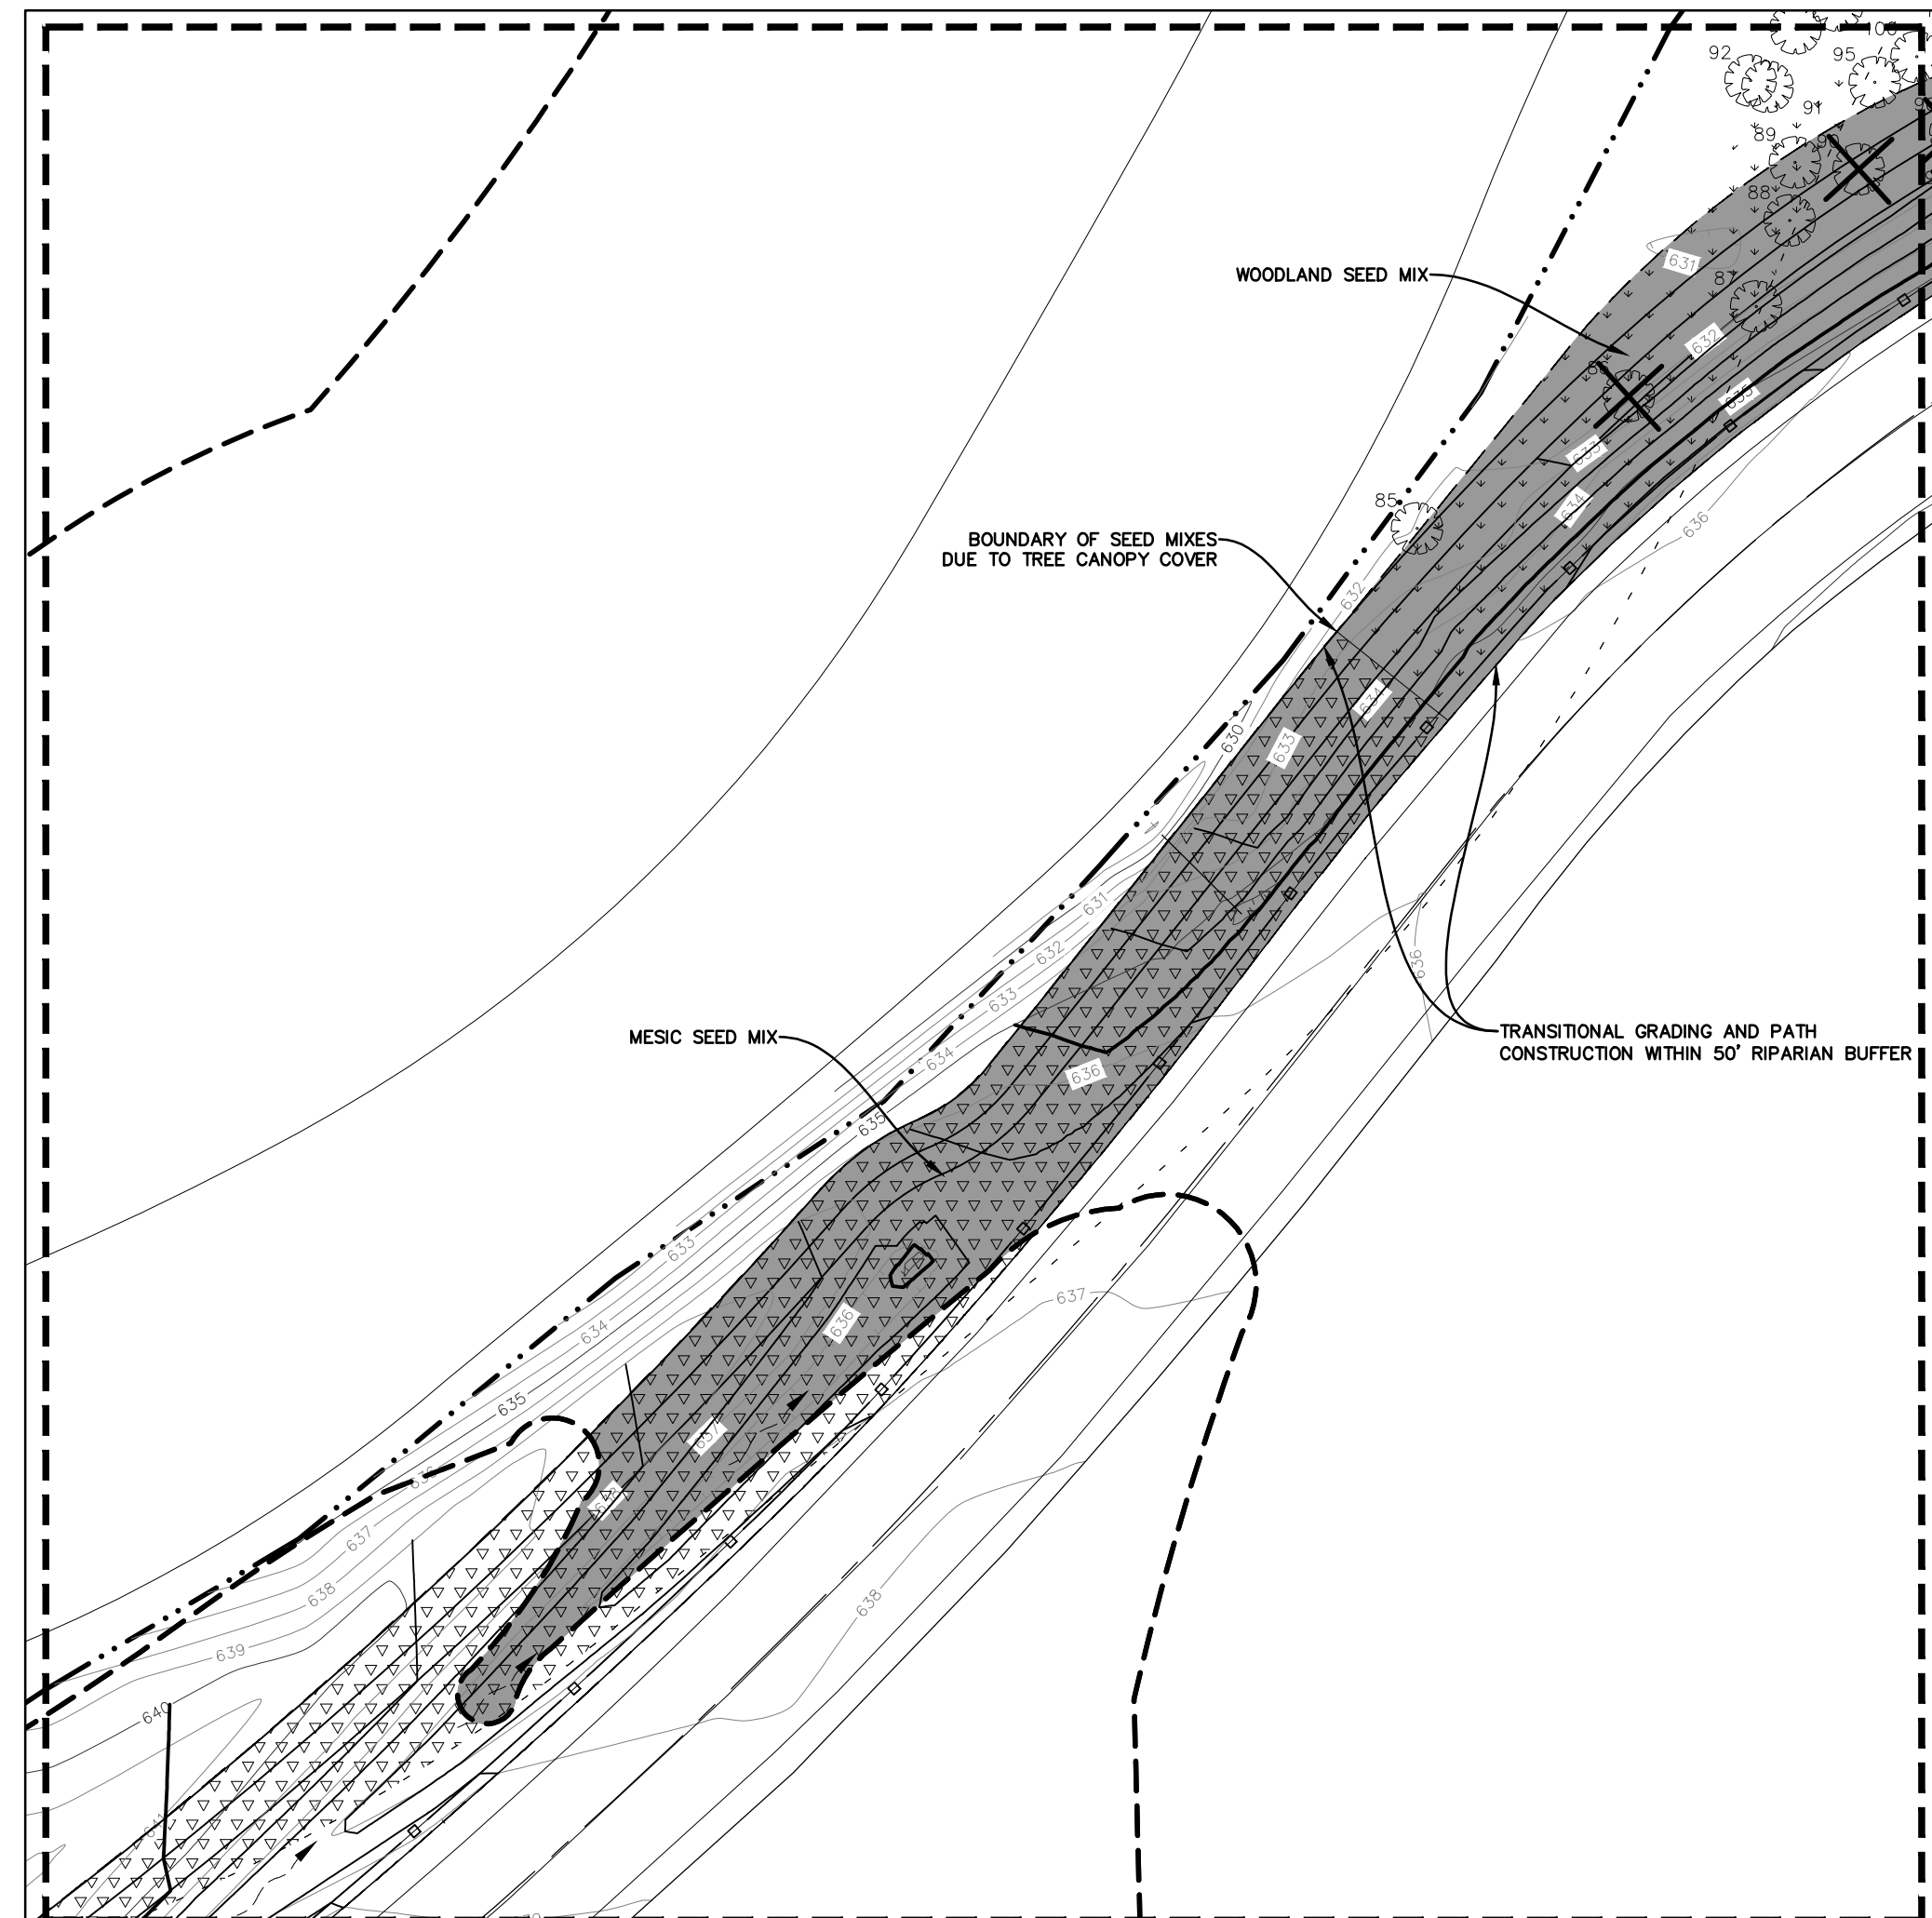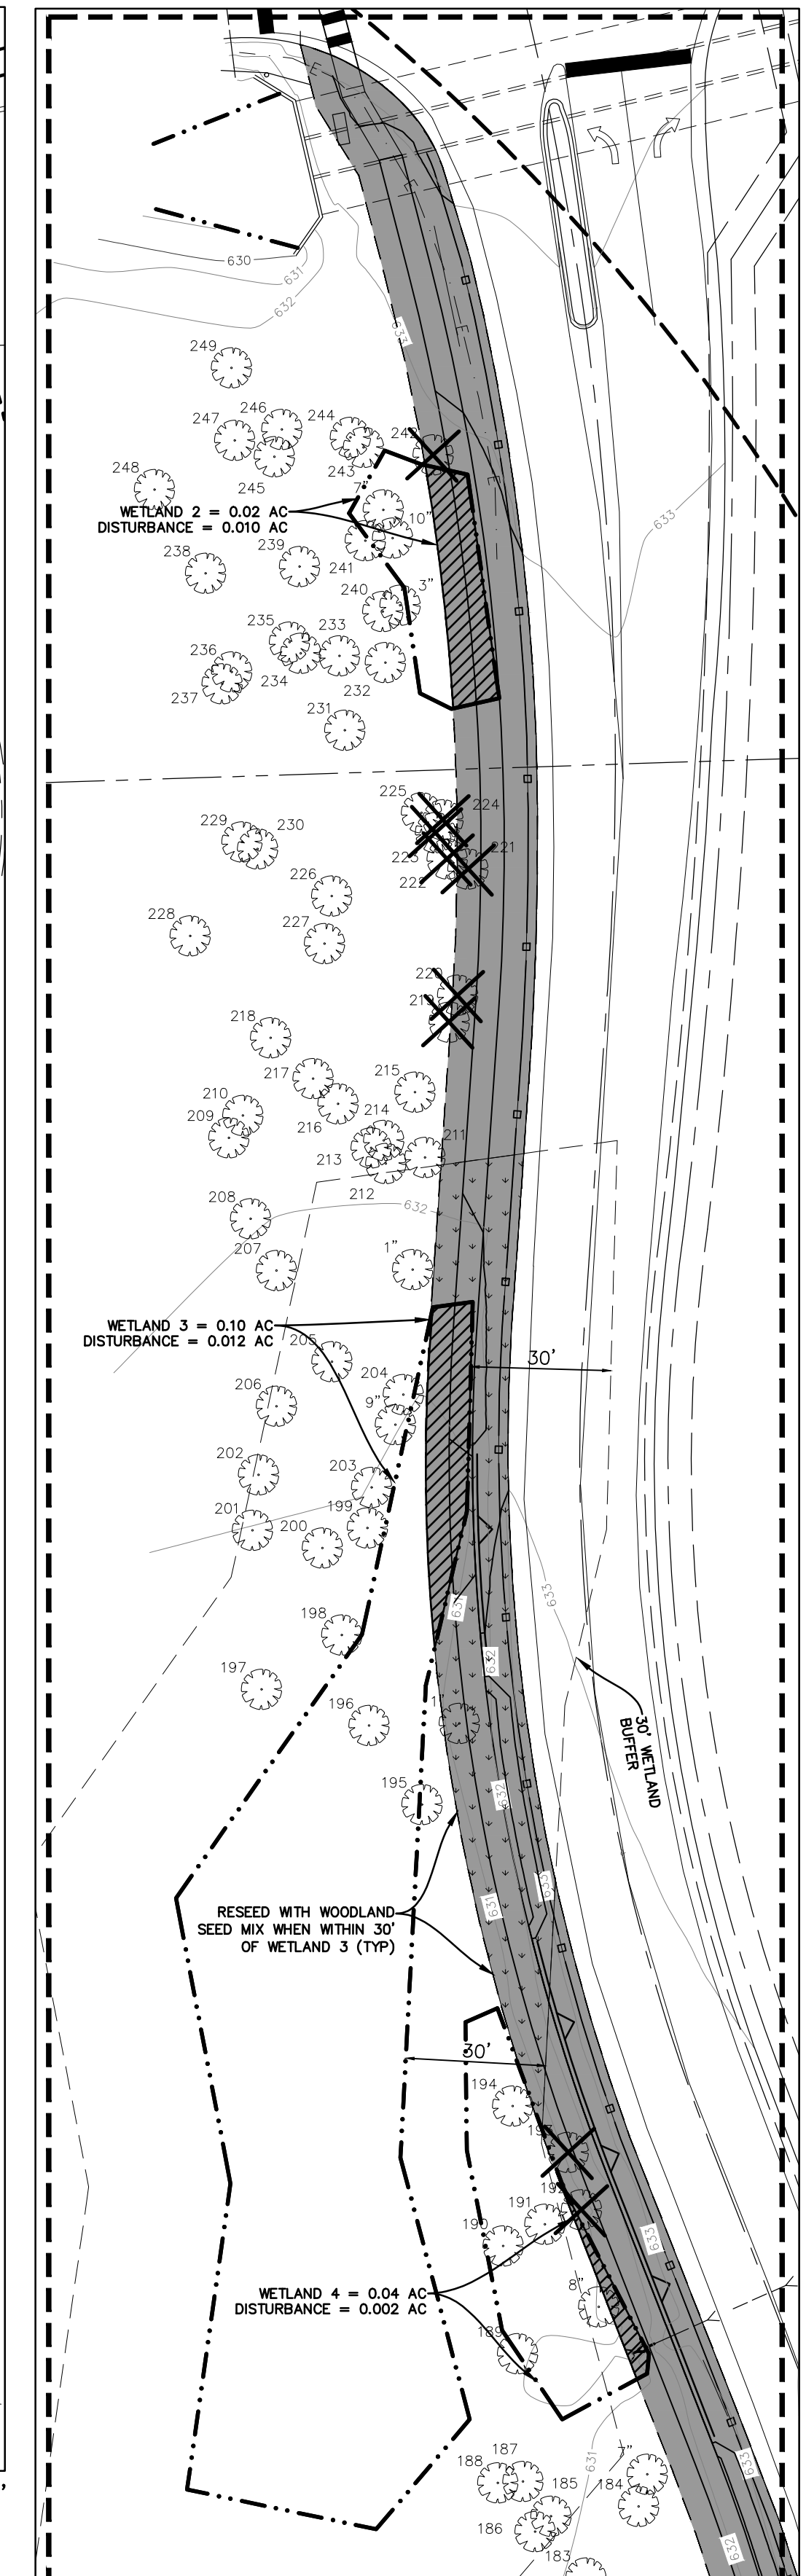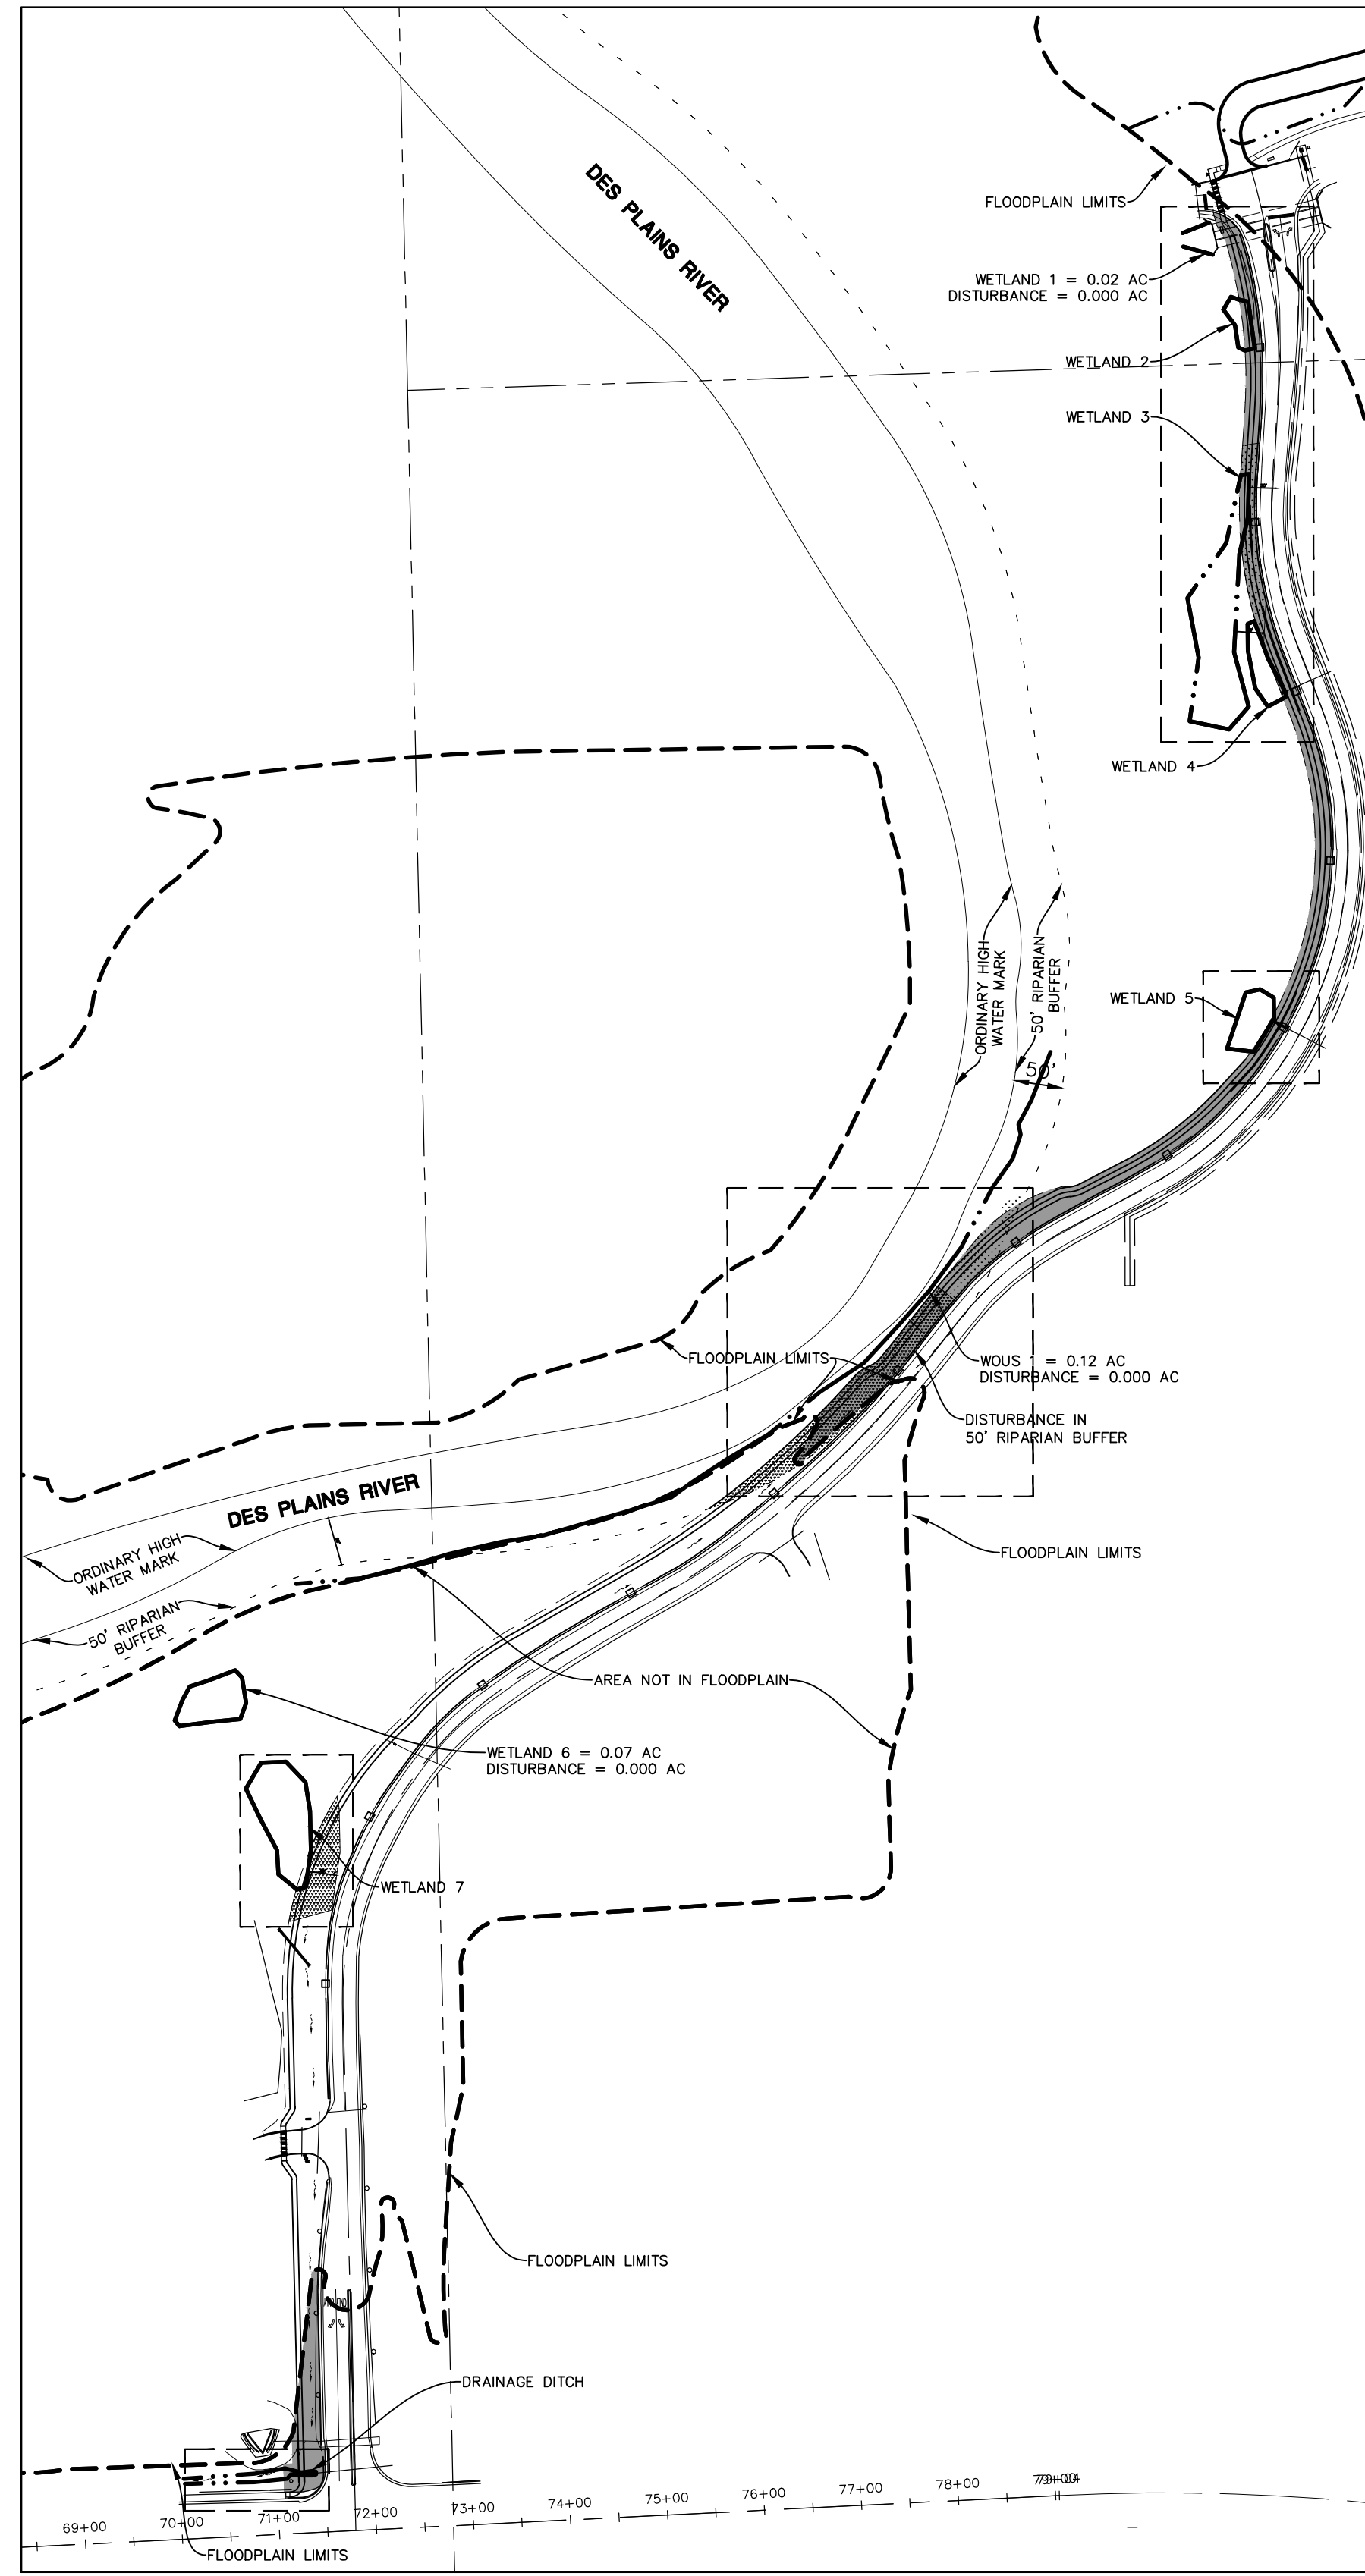

LEGEND

- LIMITS OF DISTURBANCE = 1.65 AC
- AREA OF DISTURBANCE WITHIN THE FLOODWAY (REFER TO VOLUME TABLE) AREA = 0.82 AC
- AREA OF DISTURBANCE WITHIN THE 50' RIPARIAN BUFFER (REFER TO BLOW UP DETAILS) AREA = 0.20 AC RESEED WITH MESIC OR WOODLAND SEED MIX PER BLOW UP
- AREA OF DISTURBANCE WITH WETLAND OR DRAINAGE DITCH (REFER TO BLOW UP DETAILS) RESEED WITH WETLAND EMERGENT SEED
- AREA OF DISTURBANCE WITHIN THE 30' WETLAND BUFFER (REFER TO BLOW UP DETAILS) RESEED GREEN SPACE WITH MESIC OR WOODLAND SEED MIX PER BLOW UP
- WETLAND AREA
- LIMITS OF FLOODPLAIN PER FIRM PANEL, ELEVATION = ±636
- 50' RIPARIAN BUFFER

FLOOD CUT/FILL VOLUMES

	FILL (AC-FT)	FILL*1.1 (AC-FT)	CUT (AC-FT)
0-YR THRU 10-YR FLOOD	0.08	0.09	0.10
10-YR THRU 100-YR FLOOD	0.02	0.02	0.04

*REFER TO SHEETS 19 THRU 24 OF THIS PLAN SET FOR CROSS-SECTIONS

IDENTIFICATION	AREA (AC)	AREA OF DISTURBANCE (AC)	IMPACT DESCRIPTION	MITIGATION	WETLAND BUFFER
WETLAND 1	0.02	0.000	N/A	N/A	NO BUFFER REQUIRED PER MWRD 603.10, < 0.10 AC
WETLAND 2	0.02	0.010	PATH CONSTRUCTION AND TRANSITIONAL GRADING	RESEED GREEN SPACE WITH WETLAND EMERGENT SEED MIX	NO BUFFER REQUIRED PER MWRD 603.10, < 0.10 AC
WETLAND 3	0.10	0.012	PATH CONSTRUCTION AND TRANSITIONAL GRADING	RESEED GREEN SPACE WITH WETLAND EMERGENT SEED MIX	30' MITIGATE BUFFER WITH WOODLAND SEED MIX
WETLAND 4	0.04	0.002	RELOCATED FLARED END SECTION CONSTRUCTION AND TRANSITIONAL GRADING	RESEED GREEN SPACE WITH WETLAND EMERGENT SEED MIX	NO BUFFER REQUIRED PER MWRD 603.10, < 0.10 AC
WETLAND 5	0.05	0.002	RELOCATED FLARED END SECTION CONSTRUCTION AND TRANSITIONAL GRADING	RESEED GREEN SPACE WITH WETLAND EMERGENT SEED MIX	N/A, NO DISTURBANCE IN 30' BUFFER
WETLAND 6	0.07	0.000	N/A	N/A	30' MITIGATE BUFFER WITH MESIC SEED MIX
WETLAND 7	0.13	0.005	PATH CONSTRUCTION AND TRANSITIONAL GRADING	RESEED GREEN SPACE WITH WETLAND EMERGENT SEED MIX	SEE ABOVE
TOTAL WETLANDS	0.43	0.031	SEE ABOVE	SEE ABOVE	SEE ABOVE
WOUS 1	0.12 AC LOCATED WITHIN SITE LIMITS	0.000	N/A	N/A	50' REFER TO 50' RIPARIAN BUFFER AREA BELOW
50' RIPARIAN BUFFER AREA	N/A	0.200	PATH CONSTRUCTION, FLARED END SECTION CONSTRUCTION, TRANSITIONAL GRADING AND DEMOLISH TREE 86 (RED OAK IN POOR CONDITION PER TREE INVENTORY)	RESEED GREEN SPACE WITH MESIC OR WOODLAND SEED MIX BASED ON EXISTING CANOPY COVERAGE	N/A
DRAINAGE DITCH	0.02 AC LOCATED WITHIN SITE LIMITS, THE DITCH CONTINUES TO THE WEST	0.004	PATH CONSTRUCTION, RETAINING WALL CONSTRUCTION, AND FLARED END CONSTRUCTION	N/A COORDINATING WITH IDOT	N/A

Wetland Emergent Seed Mix
 Provided by Cardno or Equal
 Note: Double installation rates shown below
 Application Rate (including cover crop) 34.38 PLS Lbs/AC

Botanical Name	Common Name	Ounces/Acre (PLS)
Permanent Grasses:		
<i>Bolboschoenus fluviatilis</i>	River Bulrush	1.00
<i>Carex canadica</i>	Bristly Sedge	2.50
<i>Carex lacustris</i>	Common Lake Sedge	0.25
<i>Carex lurida</i>	Bottebrush Sedge	4.00
<i>Carex stricta</i>	Common Tussock Sedge	1.00
<i>Carex subspinoidea</i>	Brown Fox Sedge	6.00
<i>Elymus canadensis</i>	Canada Wild Rye	1.00
<i>Juncus effusus</i>	Rice Cut Grass	3.00
<i>Leersia oryzoides</i>	Hard-stemmed Bulrush	2.50
<i>Schoenoplectus acutus</i>	Chairmaker's Rush	3.00
<i>Schoenoplectus americanus</i>	Softstem Bulrush	6.00
<i>Schoenoplectus tabernaemontani</i>		
Total		31.25
Forbs:		
<i>Aconis americanus</i>	Sweet Flag	0.50
<i>Alyssa spp.</i>	Water Plantain (Various Mix)	2.00
<i>Asclepias incarnata</i>	Swamp Milkweed	1.50
<i>Cephalanthus occidentalis</i>	Butterfly Weed	6.00
<i>Decodon verticillatus</i>	Swamp Loosestrife	0.50
<i>Echinochloa maculatum</i>	Spotted Joe-Pye Weed	0.50
<i>Hibiscus spp.</i>	Rosemallow (Various Mix)	4.00
<i>Iris virginica</i>	Blue Flag	6.00
<i>Lobelia cardinalis</i>	Cardinal Flower	0.25
<i>Lobelia siphilitica</i>	Great Blue Lobelia	0.25
<i>Lycopus americanus</i>	Common Water Horehound	0.25
<i>Mimulus ringens</i>	Morkey Flower	1.00
<i>Peltandra virginica</i>	Arrow Arum	16.00
<i>Penstemon sedoides</i>	Ditch Stonecrop	0.50
<i>Polygonum spp.</i>	Pinweed (Various Mix)	0.50
<i>Pontederia cordata</i>	Pinkwort Weed	10.00
<i>Sagittaria latifolia</i>	Common Arrowhead	2.00
<i>Spartanium eurycarpum</i>	Common Bur Reed	6.00
<i>Verbena hastata</i>	Blue Vervain	1.00
Total		58.75
Temporary Cover:		
<i>Avena sativa</i>	Common Oat	360.00
<i>Lolium multiflorum</i>	Annual Rye	100.00
Total		460.00

Notes:
 1) For best results install Myco Seed Treat inoculum to above seed mix at 4 oz per 100 lbs of seed, or equal
 2) install proper erosion control (blanket or heavy hydro-mulching) immediately after installation
 3) Do not seed in standing water. If location has perpetually standing water install plugs
 4) If site needs to be well vegetated in first season, install Echinochloa crus-galli at 2lbs/ac. Manage closely

Mesic Prairie Seed Mix (CARDO)

Botanical Name	Common Name	PLS Ounces/Acre
Permanent Grasses:		
<i>Andropogon gerardii</i>	Big Bluestem	12.00
<i>Bouteloua curtipendula</i>	Side-Oats Grama	16.00
<i>Carex spp.</i>	Prairie Sedge Species	3.00
<i>Elymus canadensis</i>	Canada Wild Rye	24.00
<i>Panicum virgatum</i>	Switch Grass	2.50
<i>Schizachyrium scoparium</i>	Little Bluestem	32.00
<i>Sorghastrum nutans</i>	Indian Grass	12.00
Total		101.50
Temporary Cover:		
<i>Avena sativa</i>	Common Oat	360.00
<i>Lolium multiflorum</i>	Annual Rye	100.00
Total		460.00

Forbs:

Botanical Name	Common Name	PLS Ounces/Acre
<i>Asclepias syriaca</i>	Common Milkweed	1.00
<i>Asclepias tuberosa</i>	Butterfly Weed	1.00
<i>Chamaecrista fasciculata</i>	Partridge Pea	10.00
<i>Coreopsis lanceolata</i>	Sand Coreopsis	6.00
<i>Echinacea purpurea</i>	Broad-Leaved Purple Coneflower	8.00
<i>Helopsis helianthoides</i>	False Sunflower	0.25
<i>Monarda fistulosa</i>	Wild Bergamot	0.50
<i>Penstemon digitalis</i>	Foxglove Beard Tongue	1.00
<i>Ratibida pinnata</i>	Yellow Coneflower	4.00
<i>Rudbeckia hirta</i>	Black-Eyed Susan	8.00
<i>Solidago speciosa</i>	Showy Goldenrod	0.50
<i>Symphoricarum laeve</i>	Smooth Blue Aster	1.00
<i>Symphoricarum novae-angliae</i>	New England Aster	0.50
Total		41.75

Woodland Species Seed Mix

Species	Common Name	Oz/Acre
<i>Graminoid</i>		
<i>Bromus pubescens</i>	Hairy woodland brome	3.00
<i>Carex blanda</i>	Common woodland sedge	2.00
<i>Carex davisi</i>	Awned Graceful Sedge	3.00
<i>Carex normalis</i>	Oval sedge	2.00
<i>Cinna arundinacea</i>	Wood reed	3.00
<i>Elymus virginicus</i>	Virginia wildrye	5.00
<i>Festuca subverticillata</i>	Nodding fescue	2.00
<i>Glyceria striata</i>	Fowl manna grass	2.00
<i>Hystrix patula</i>	Bottebursh grass	8.00
Total Ounces		30.00

Forbs

Botanical Name	Common Name	Oz/Acre
<i>Agastache scrophulariaefolia</i>	Purple giant hyssop	2.00
<i>Agastache nepetoides</i>	Yellow giant hyssop	2.00
<i>Anemone canadensis</i>	Canadian anemone	2.00
<i>Eutrochium purpureum</i>	Purple joe pye weed	2.00
<i>Geranium maculatum</i>	Spotted geranium	1.00
<i>Heracleum maximum</i>	Short's aster	2.00
<i>Hydrophyllum virginianum</i>	Virginia Waterleaf	4.00
<i>Lycopus americanus</i>	American water horehound	1.00
<i>Monarda fistulosa</i>	Wild bergamot	2.00
<i>Penstemon calycosus</i>	Smooth beard tongue	2.00
<i>Penstemon digitalis</i>	Foxglove beard tongue	2.00
<i>Rudbeckia subtomentosa</i>	Sweet Black-eyed Susan	2.00
<i>Symphoricarum lateriflorum</i>	Calico aster	2.00
<i>Symphoricarum shortii</i>	Short's aster	2.00
<i>Thalictrum dioicum</i>	Early meadow-rue	2.00
<i>Tradescantia ohniensis</i>	Common spiderwort	4.00
<i>Zizia aurea</i>	Golden Alexanders	3.50
Total Ounces		37.50


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PEDESTRIAN AND BICYCLE PATHWAY
OAKTON COMMUNITY COLLEGE - DES PLAINES CAMPUS
FLOODPLAIN-FLOODWAY, WETLAND AND RIPARIAN EXHIBIT



PROJ. MGR.: DBM
 PROJ. ASSOC.: JWS
 DRAWN BY: JWS
 DATE: 05-04-21
 SCALE: 1"=XX'

SHEET
30 OF 30
 OCCDPIL10


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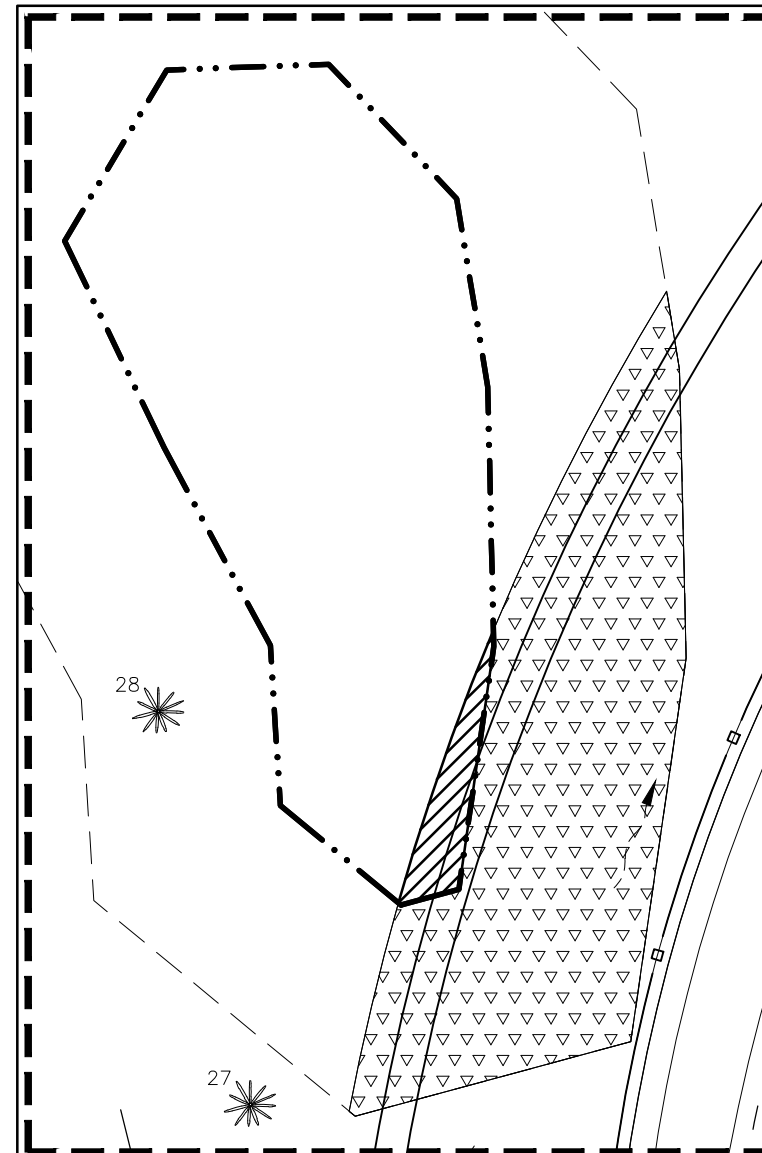
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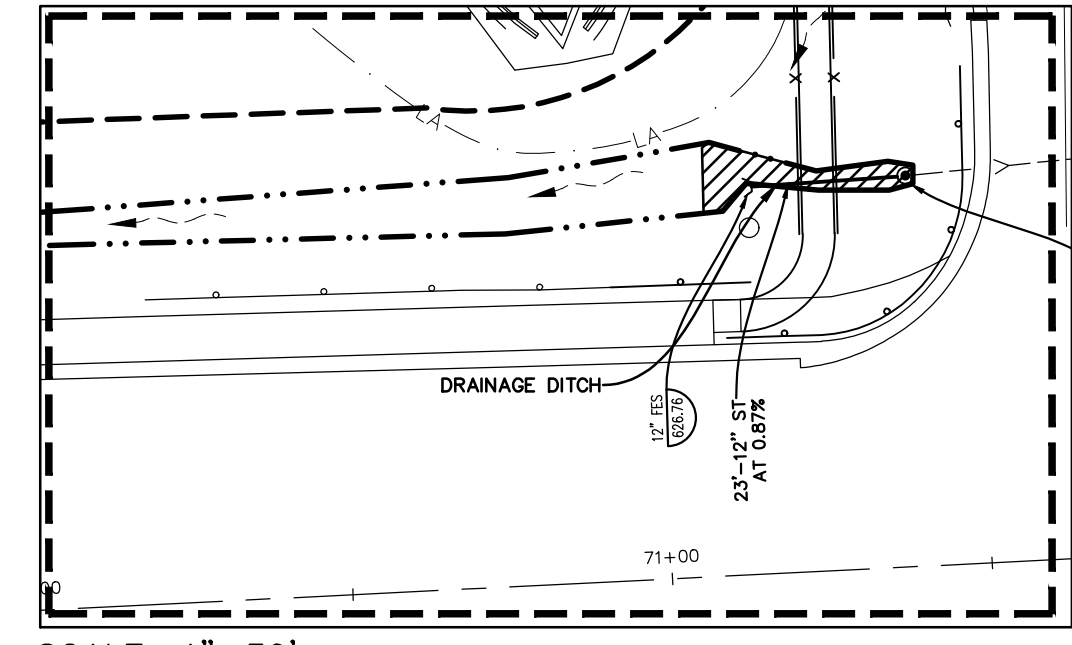
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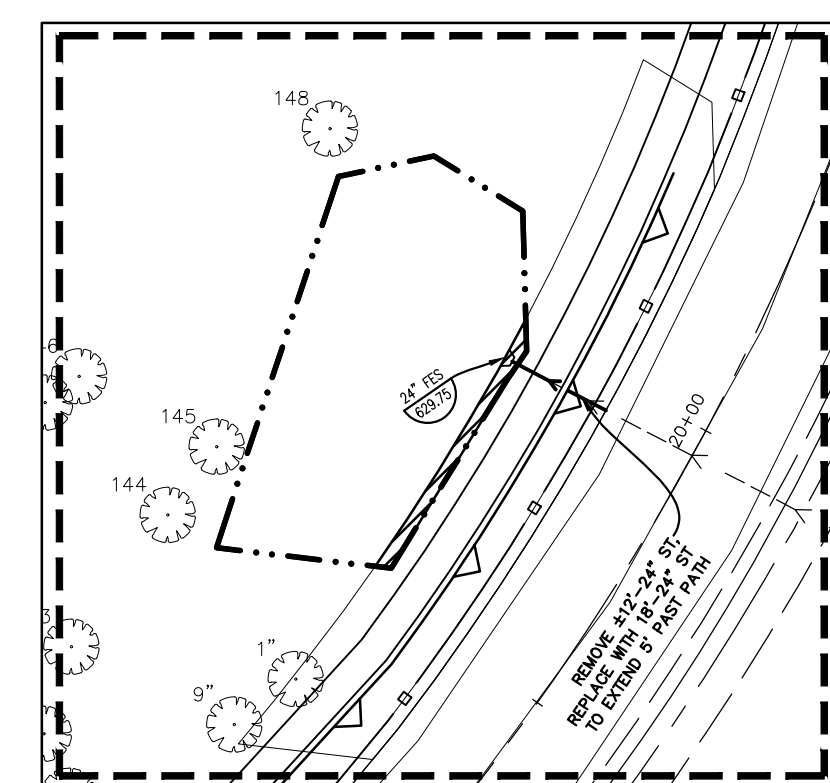
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SCALE: 1"=30'

MAINTENANCE PLAN FOR PEDESTRIAN AND BICYCLE ALONG COLLEGE DRIVE
 The Owner of the Pedestrian and Bicycle Pathway along College Drive, with facilities as shown on this Maintenance and Monitoring Exhibit, shall assume responsibility for the following perpetual maintenance activities:

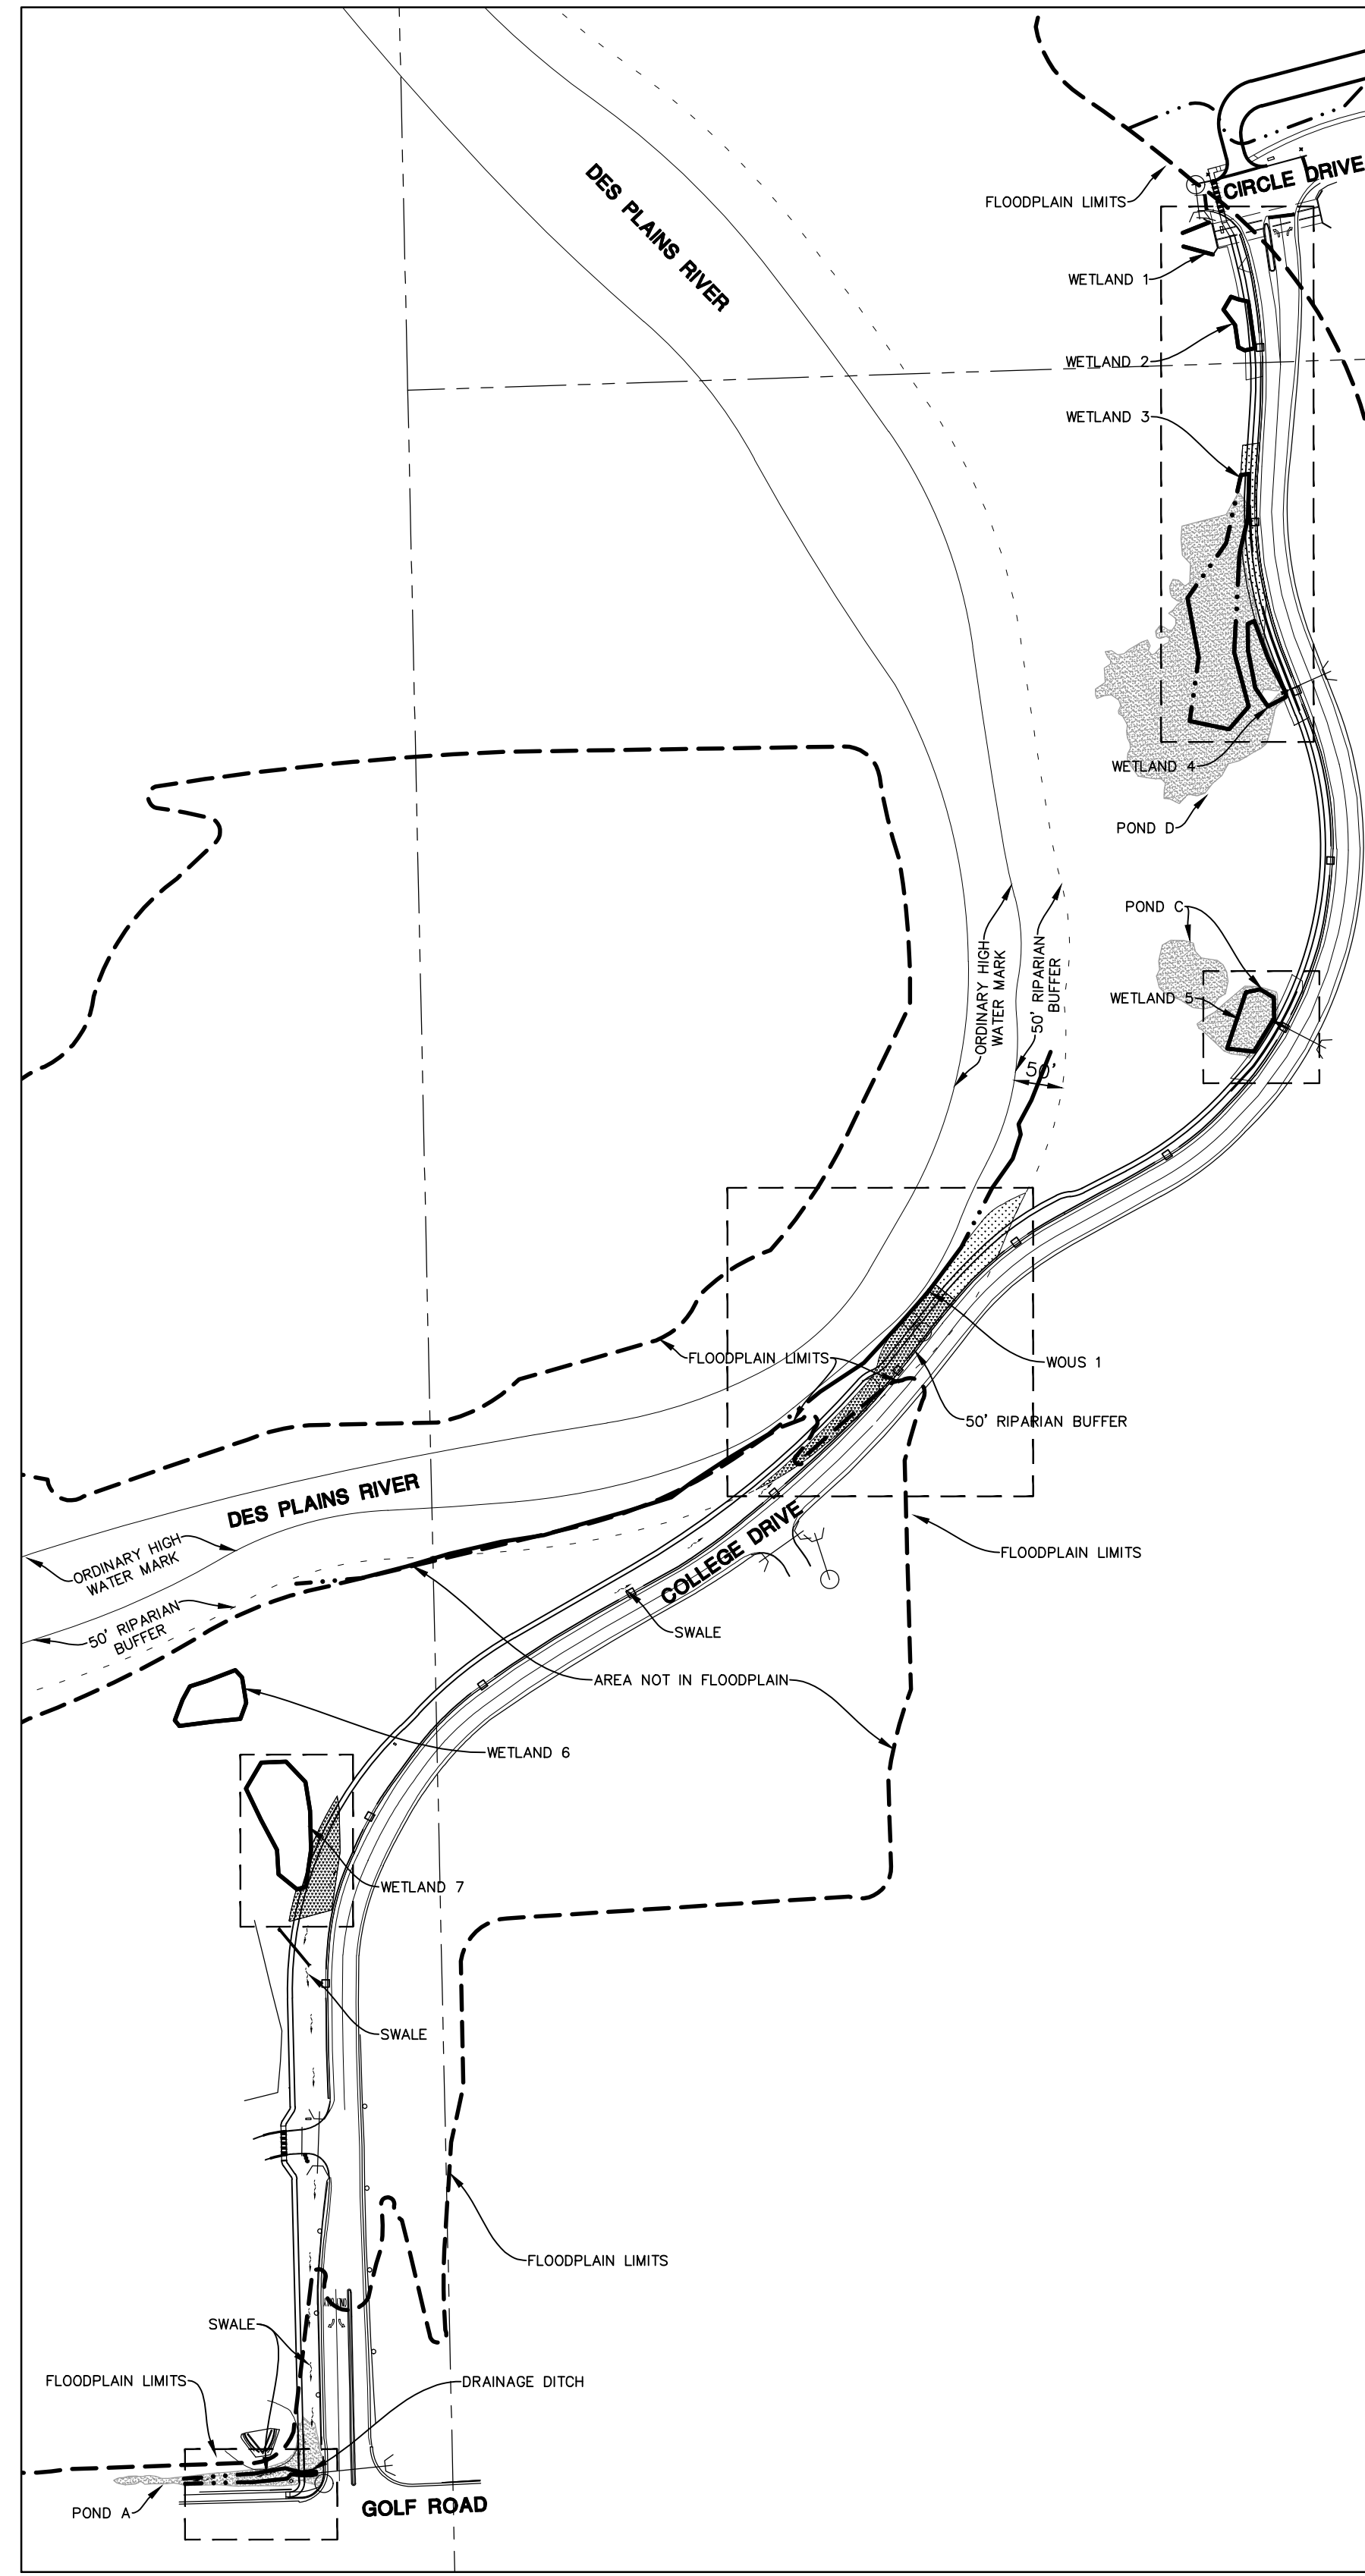- General**
 Regular inspections and routine maintenance of general areas shall be performed on a monthly or as-needed basis. Specific items of concern include:
 - Litter and debris shall be controlled.
 - Landscaped areas shall be maintained with regular mowing and restored with appropriate seeding/vegetation as necessary. Accumulated sediment shall be disposed of properly, along with any wastes generated during maintenance operations.
 - Riprap areas shall be repaired with the addition of new riprap, as necessary, of similar size and shape.
 - Roads shall be swept, vacuumed and/or washed on a regular basis.
- Stormwater Management Facilities**
 All components of the stormwater management facilities shall be checked monthly between March and November and maintained as necessary to ensure proper performance. It is critical that all inflows and outflows to the detention facility are clean and performing as designed. In addition, the design volume of the detention facility shall also be maintained. Inspections for the following specific items should be conducted monthly between March and November:
 - Side Slopes/Embankment/Emergency Overflow Structure
 - Inspect embankments for settlement and erosion
 - Remove woody growth from the embankment
 - Any breaks, hire Registered professional Engineer for design resolution
 - Seed and sod any eroded areas
 - Signs of piping (leakage) or seepage, repair
 - Stabilize emergency overflow structure if erosion observed
 - Remove obstructions blocking emergency overflow spillway
 - Vegetated Areas
 - Regular mowing to control vegetation, no cutting of native vegetation
 - Need for planting, reseeding or sodding. Supplement alternative native vegetation if a significant portion has not established (50% of the surface area). Reseed with alternative grass species if original grass cover has not successfully established.
 - Evidence of grazing, motorbikes or other vehicles, repair
 - Check for invasive vegetation, remove where possible
 - All vegetation must be maintained per the approved planting plan
- Access for Maintenance Equipment**
 Remove any obstructions placed in maintenance easements
- Safety Features**
 - Access controls to hazardous areas
 - Fences
 - Loose or damaged posts
 - Loose or broken wires
 - Condition of gates
 - Signs
- Detention Volume**
 - Inspect all stormwater detention facilities to ensure that the constructed volume for detention is maintained. No sediment, topsoil, or other dumping into the facility shall be allowed. Specific locations in the stormwater management system, designed to accumulate sediment, shall be dredged as necessary to prevent sediment from reaching the invert of any gravity outlet pipe.
- Stormwater Collection System**
 The Owner shall perform monthly inspections of all components of the stormwater collection system. The monthly inspection shall occur between March and November and include the following specific areas of concern:
 - Storm Sewers/Culverts
 - Visually inspect pipes by removing manhole lids, make repairs as necessary
 - Storm sewers and culverts shall be checked for siltation deposits at inlets, outlets, and within the conduit, clean out as necessary
 - Restore riprap at outfalls if erosion observed
 - Replant and reseed any eroded areas
- Overland Flow Routes (Ditches/Swales)**
 - Annual visual inspections shall be performed that verify the design capacity of the overland flow routes is maintained. The slope and cross-sectional area of the ditch/swale shall be verified during this inspection. Remove any obstructions that have been placed in the drainage path
 - Seed and sod any eroded areas
 - Restore riprap as necessary
 - Regrade to provide positive drainage as necessary
 - Regular mowing to control vegetation
- Vegetated Areas**
 Need for planting, reseeding, or sodding. Supplement alternative native vegetation if a significant portion has not established (50% of the surface area after second growing season). Reseed with alternative native grass species if original grass cover has not successfully established.
 - Evidence of grazing, motorbikes, or other vehicles, repair.
 - Check for invasive vegetation, remove when possible. Regular mowing to control vegetation; is recommended that native vegetation remain uncut.
 - Dead or damaged non-native grassy areas -- repair with seeding with fertilization or seeding with mulch.
 - Compensatory storage area shall be reseeded with appropriate vegetation according to the approved planting plan.

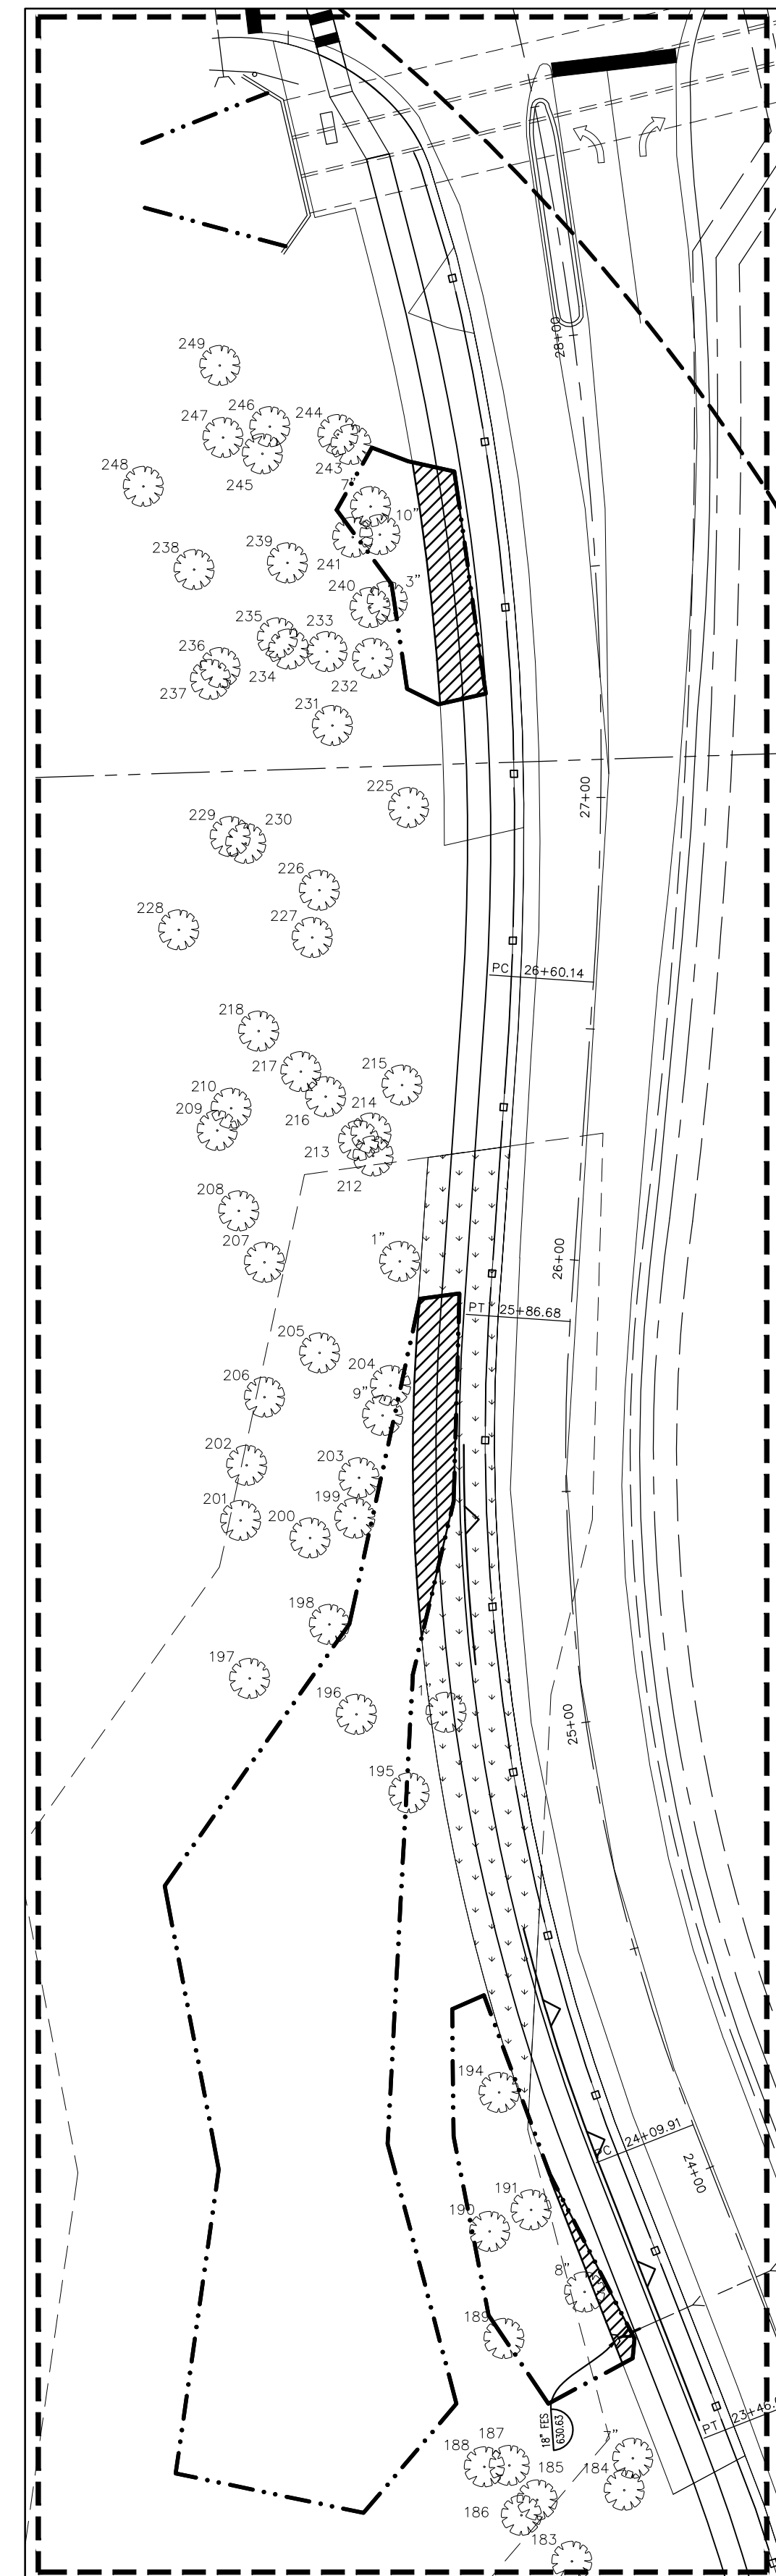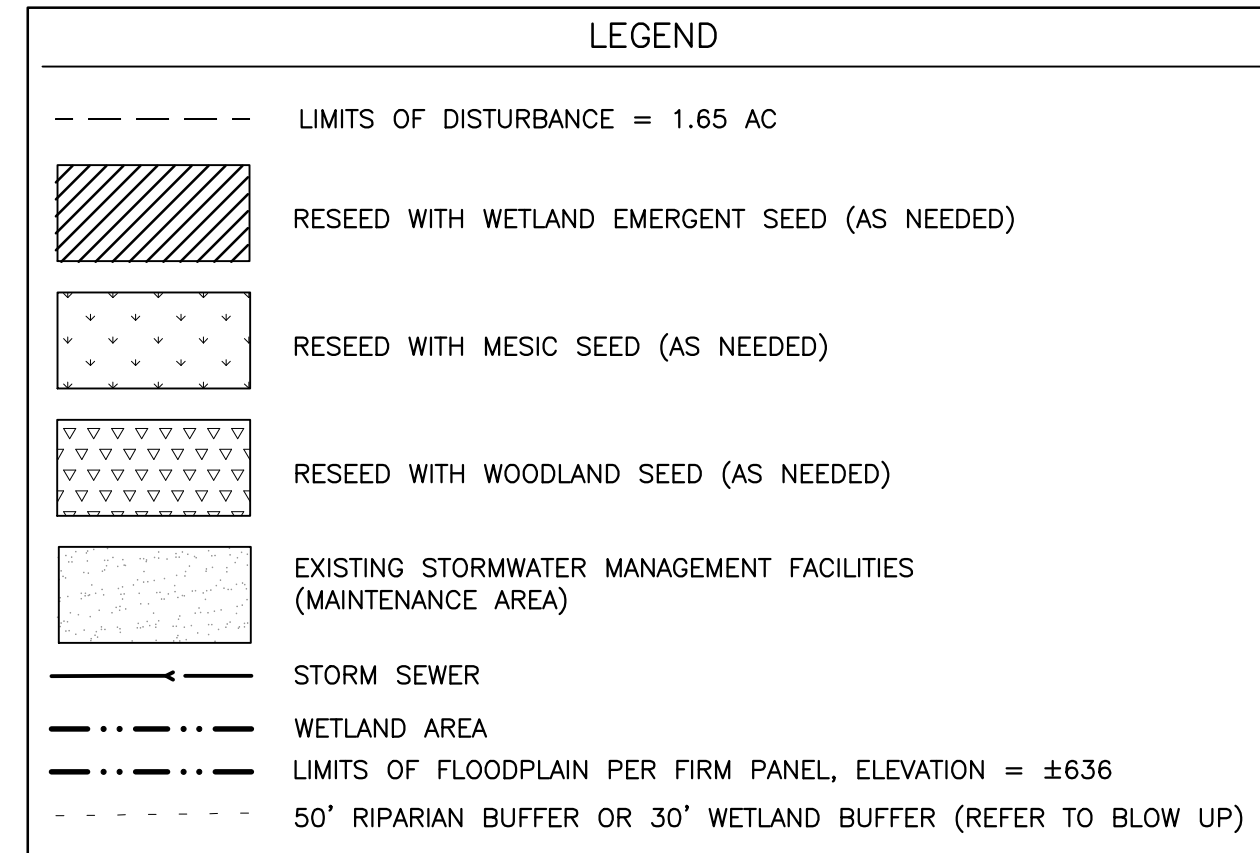PROJECT SITE SUMMARY		
PROPERTY LOCATION: WEST SIDE OF COLLEGE DRIVE FROM GOLF ROAD TO CIRCLE DRIVE IN DES PLAINES, IL		
PROPERTY INDEX NUMBER(S): 09-08-400-013 09-09-300-021 09-09-300-004 09-08-200-006		
TOTAL CONTIGUOUS OWNERSHIP: 171.4 ACRES		
DEVELOPMENT AREA: 1.65 ACRES		

FLOOD CUT/FILL VOLUMES			
	FILL (AC-FT)	FILL*1.1 (AC-FT)	CUT (AC-FT)
0-YR THRU 10-YR FLOOD	0.08	0.09	0.11
10-YR THRU 100-YR FLOOD	0.02	0.03	0.06

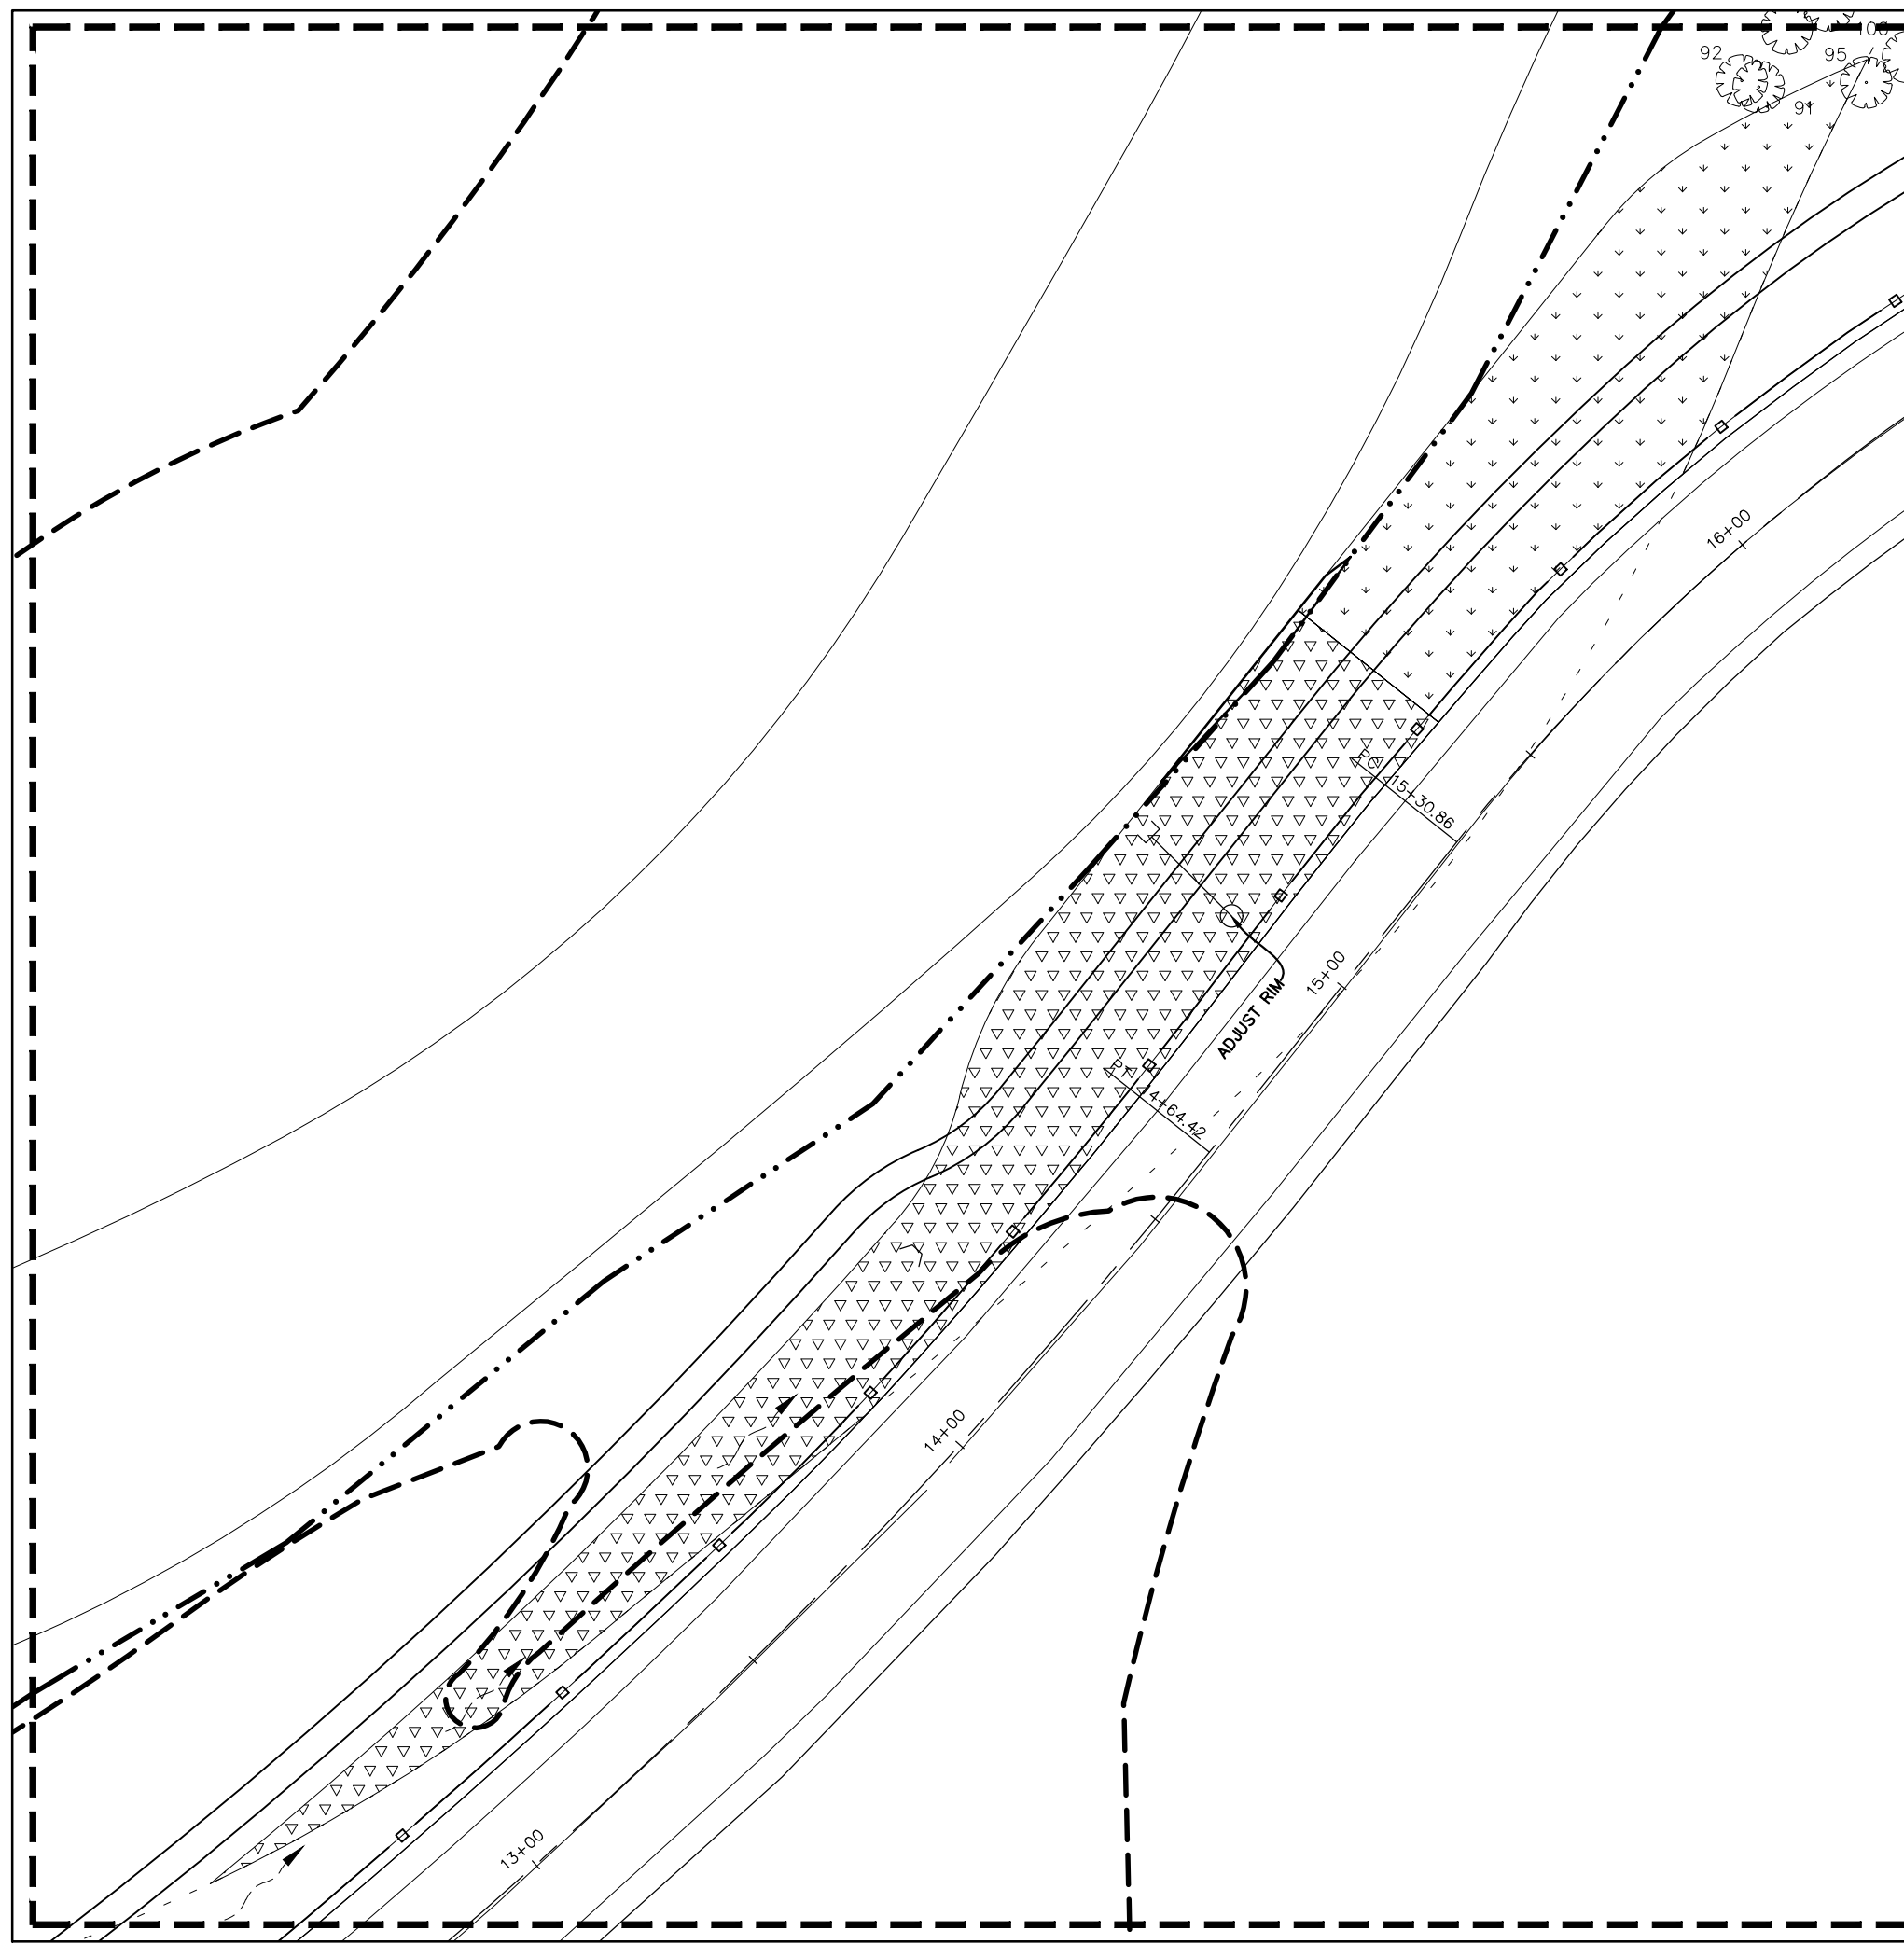*REFER TO SHEETS 19 THRU 24 OF THIS PLAN SET FOR CROSS-SECTIONS

DRAWN BY: JWS
 CHECKED BY: CRM
 DATE: 05-04-21
 SCALE: 1"=30'
 SHEET 30A OF 30
 OCCDPIL10

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PEDESTRIAN AND BICYCLE PATHWAY
OAKTON COMMUNITY COLLEGE - DES PLAINES CAMPUS
MAINTENANCE AND MONITORING EXHIBIT

PROJECT MGR.: DBM
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 SHEET 30A OF 30
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